

Andrew MacNichol Senior Planner Phone: 781.942-6670

Fax: 781.942-9071

Website: www.readingma.gov

November 7, 2022

Minor Site Plan Review DECISION

Project/Site: 48-54 Village Street

To the Town Clerk:

This is to certify that, at a meeting of the Community Planning and Development Commission on November 7, 2022, by a motion duly made and seconded, it was voted:

"We, the Reading Community Planning and Development Commission, upon request from Kevin Emery, for Minor Site Plan Review for the property located at 48-54 Village Street (Assessors Map 17, Lot 192), for an increase of over 500 square feet of Gross Floor Area in new floor area, as presented in the application materials enumerated below, do hereby vote XXX, to ______the project under Minor Site Plan Review in accordance with Section 4.6.3 of the Reading Zoning Bylaw, subject to the Findings and Conditions below."

Materials Submitted:

The following materials were submitted into the public record:

- 1. Certified Abutters List, dated 8/29/22;
- 2. Minor Site Plan Review Courtesy Notice of Public Meeting to Abutters;
- 3. Minor Site Plan Review Application, received 10/24/22;
- 4. Plot Plan of Land, depicting proposed 4-unit dwelling, prepared by D&A Survey Associates, Inc., for land of 48-54 Village Street, Reading, MA, dated 9/5/22;
 - a. Plot Plan of Land depicting proposed 4-unit dwelling and existing dwelling overlay, dated 9/5/22;
- Architectural Plan Sheets and Elevations consisting of Sheets A1 through A8, prepared by Robert M. Connell, dated 2022;
- 6. Draft Decision, dated 11/7/22;

Findings:

- 1) Applicability: The proposed work requires Minor Site Plan Review approval under Zoning Bylaw Section 4.6.2.3(a), "An increase in gross floor area of 500 square feet or more either by the creation of new floor area or by the expansion of an existing use into adjacent space within an existing structure"
- Site/Zoning: The site is located in the S-15 Residential Zoning District. The lot totals 7,899
 square-feet of area and maintains 75.60 linear feet of frontage along the public way of Village
 Street.

1

- 3) Existing Conditions: The site maintains a legal non-conforming four-unit multi-family dwelling constructed approximately 1890. The dwelling also maintains a pre-existing non-conforming front-yard setback of 13.2-feet where 20-feet is required. It includes eight (8) off-street parking spaces and enclosed porches for residential use.
- 4) Overview: The Applicant is proposing to raze the existing four-unit dwelling and develop a newly constructed four-unit property. The new development adds over 500 square-feet of Gross Floor Area for the multi-family use than previously maintained.
 - a. <u>Proposed Use</u>: To maintain the pre-existing use of a legal non-conforming four-unit multi-family property. Each unit will maintain three (3) bedrooms, living, dining, kitchen, bathroom and storage areas across two-floors. Each unit will also include private decks that are 6-feet deep. The units will be for-sale and to be maintained by a future Condo Association.

b. <u>Dimensional Controls</u>:

- i. Height: The proposed building will maintain an average height of 32-feet, where 35-feet is required. It will measure 30-feet from the front along Village Street (3-story appearance) and 36-feet, 8-inches from the rear (4-story appearance) due to the natural grade change of the site. The building will maintain a flat roof with parapet design.
- ii. <u>Setbacks</u>: The proposed dwelling will confirm to all setback requirements of the S-15 Zoning District it is located in.
- iii. <u>Lot Coverage</u>: The proposed dwelling will occupy 24.93% of lot area (1,969 square-feet/7,899 square-feet), where up to 25% is allowed. Impervious parking area is not considered in the calculation.
- c. Parking: The proposed development will maintain the pre-existing parking count of eight (8) standard parking spaces, where six (6) parking spaces are required. Each unit will be deeded two (2) parking spaces, that will be tandem in style. There is a 'No Parking This Side' regulation along the property frontage on Village Street.
- 5) Zoning Board Approval: At the meeting of October 18, 2022 the Zoning Board of Appeals (ZBA) voted to issue a Special Permit to allow the proposed re-construction of a pre-existing, non-conforming use of a four-unit multi-family development in the S-15 Zoning District.
- 6) Landscape: Any trees proposed for removal? New plantings along front or side? Fencing?

Other CPDC Comments (i.e. trash, lighting, etc.)

Conditions:

General:

- 1. **Limitations / Future Uses:** The Decision herein does not include approval for any future uses or site renovations that may on their own merits and design trigger the requirements of future site plan review, and/or require a special permit.
- 2. **Public Health, Safety and Welfare:** If, at any time, the site becomes a nuisance to public health, safety or welfare (i.e., traffic spillover, excessive noise, unreasonable site illumination beyond the hours of operation, etc.) as shall be evidenced by substantiated complaints to the Police Department or Public Services Office the Applicant/Owner shall agree to work with

Commented [MA1]: Can Applicant confirm?

Commented [MA2]: I believe Section 6.5 will apply under, "...and into new multi-family dwelling projects."

Commented [MA3R2]: However, these are pre-existing parking areas being maintained. The ZBA did approved the continued non-conforming use but this requirement was not specified during the hearing/decision.

- staff to rectify the problem. Should the situation warrant it, an additional Site Plan Review by the CPDC may be required.
- 3. **Signage:** No site identification signage is approved with this application. The Applicant shall submit a Sign Permit Application, for review and approval by the Community Development Director, prior to installing any non-directional or ADA signage.
- 4. **Permitting:** The approval herein is for Minor Site Plan Review only. The Applicant shall seek building, electrical, plumbing, and gas permits as needed for the work.
- 5. **Lighting:** Light fixtures shall be installed/adjusted to minimize impacts on traffic.

Prior to the Issuance of Building Permit:

- Construction Documents & Fire Safety: As required, full construction documents shall be submitted and approved by the Fire Department at 80% design. A fire flow test shall also be performed prior to the issuance of a building permit. A building permit shall not be issued until the Fire Department has approved the plans and test findings.
- Other Permits: The Owner/Applicant is responsible for obtaining all other requirements and
 permits including but not limited to, utility connections, sewer, water, curb cut, street opening
 and Jackie's Law excavation permits from the Engineering Department (prior to excavation),
 and Board of Health approvals.

During Construction:

- Construction Hours: Construction shall be limited to the hours specified in General Bylaw Section 8.9.8.
- 7. Construction Activities: Construction activities shall be conducted in a workmanlike manner at all times. Blowing dust or debris shall be controlled by the Applicant through stabilization, wetting down, and proper storage and disposal methods, subject to the approval of the Health Agent or designee. The Applicant shall ensure that the abutting local streets are kept clear of dirt and debris, which may accumulate as a result of construction activities for the Project. Documentation shall be provided demonstrating ongoing pest management control, subject to the approval of and administration by the Health Agent.
- 8. **Site Inspections:** Town staff or their designee shall have reasonable access to inspect the site to determine compliance with this Decision.

Prior to the Issuance of Occupancy:

9. **Architecture:** The building façade on each elevation (north, south, east, and west) shall be substantially as indicated on the approved plans and elevations.

Conditions for Ongoing Maintenance After Occupancy:


10. Landscaping: Landscaping on-site shall be maintained in a healthy condition in perpetuity. In the event that landscaping is damaged during snow removal operations, the property owner shall replace such landscaping during the next growing season.

Modifications/Revisions - Plan Changes after Approval by the Approving Authority:

Contemplated future changes to the plan approved herein shall be presented to the Community Development Director and the Zoning Enforcement Officer/Building Inspector, or other relevant Town staff, for review prior to implementation of proposed changes.

- 1. Minor Modification: Changes that do not substantially alter the concept of the approved Plan in terms of the specific location, the proposed land use, the design of building form and approved building details and materials, site grading or egress points. These include but are not limited to small changes in site layout, topography, architectural plans, landscaping plan, traffic circulation, parking, lighting, signage, open space or other criteria set forth in Section 4.6.9.1. Requests for approval under a minor modification for future renovations/alterations to the approved site plan or for future tenant changes shall be reviewed by the Community Development Director to determine if the proposed work qualifies for review through the Minor Site Plan Review process of Section 4.6.3 of the Reading Zoning Bylaw. If the work is eligible for review under Minor Site Plan review, the Community Development Director may review and grant approval of the proposed work by administrative approval of the Minor Modification. At the determination of the Community Development Director, the Applicant may be required to present the proposed project at a public meeting of the CPDC.
- 2. Major Modification: Substantial additions, deletions or deviations from the approved plan, including but not limited to changes in site layout, topography, architectural plan, landscaping plans, traffic circulation, parking, lighting plan, signage, open space or other criteria set forth in Section 4.6.9.1 of the Reading Zoning Bylaw. (Note: Approval of the major modification shall be grounds for reconsideration of the Site Plan application. Denial of proposed major modifications shall not invalidate the Site Plan in conformance with the previously approved Plan).

Signed as to the accuracy of the vote as reflected in th	e minutes:
Andrew MacNichol, Senior Planner	Date
Cc: Applicant, Town Clerk, CPDC, Development Review T	eam, Building Inspector, planning file

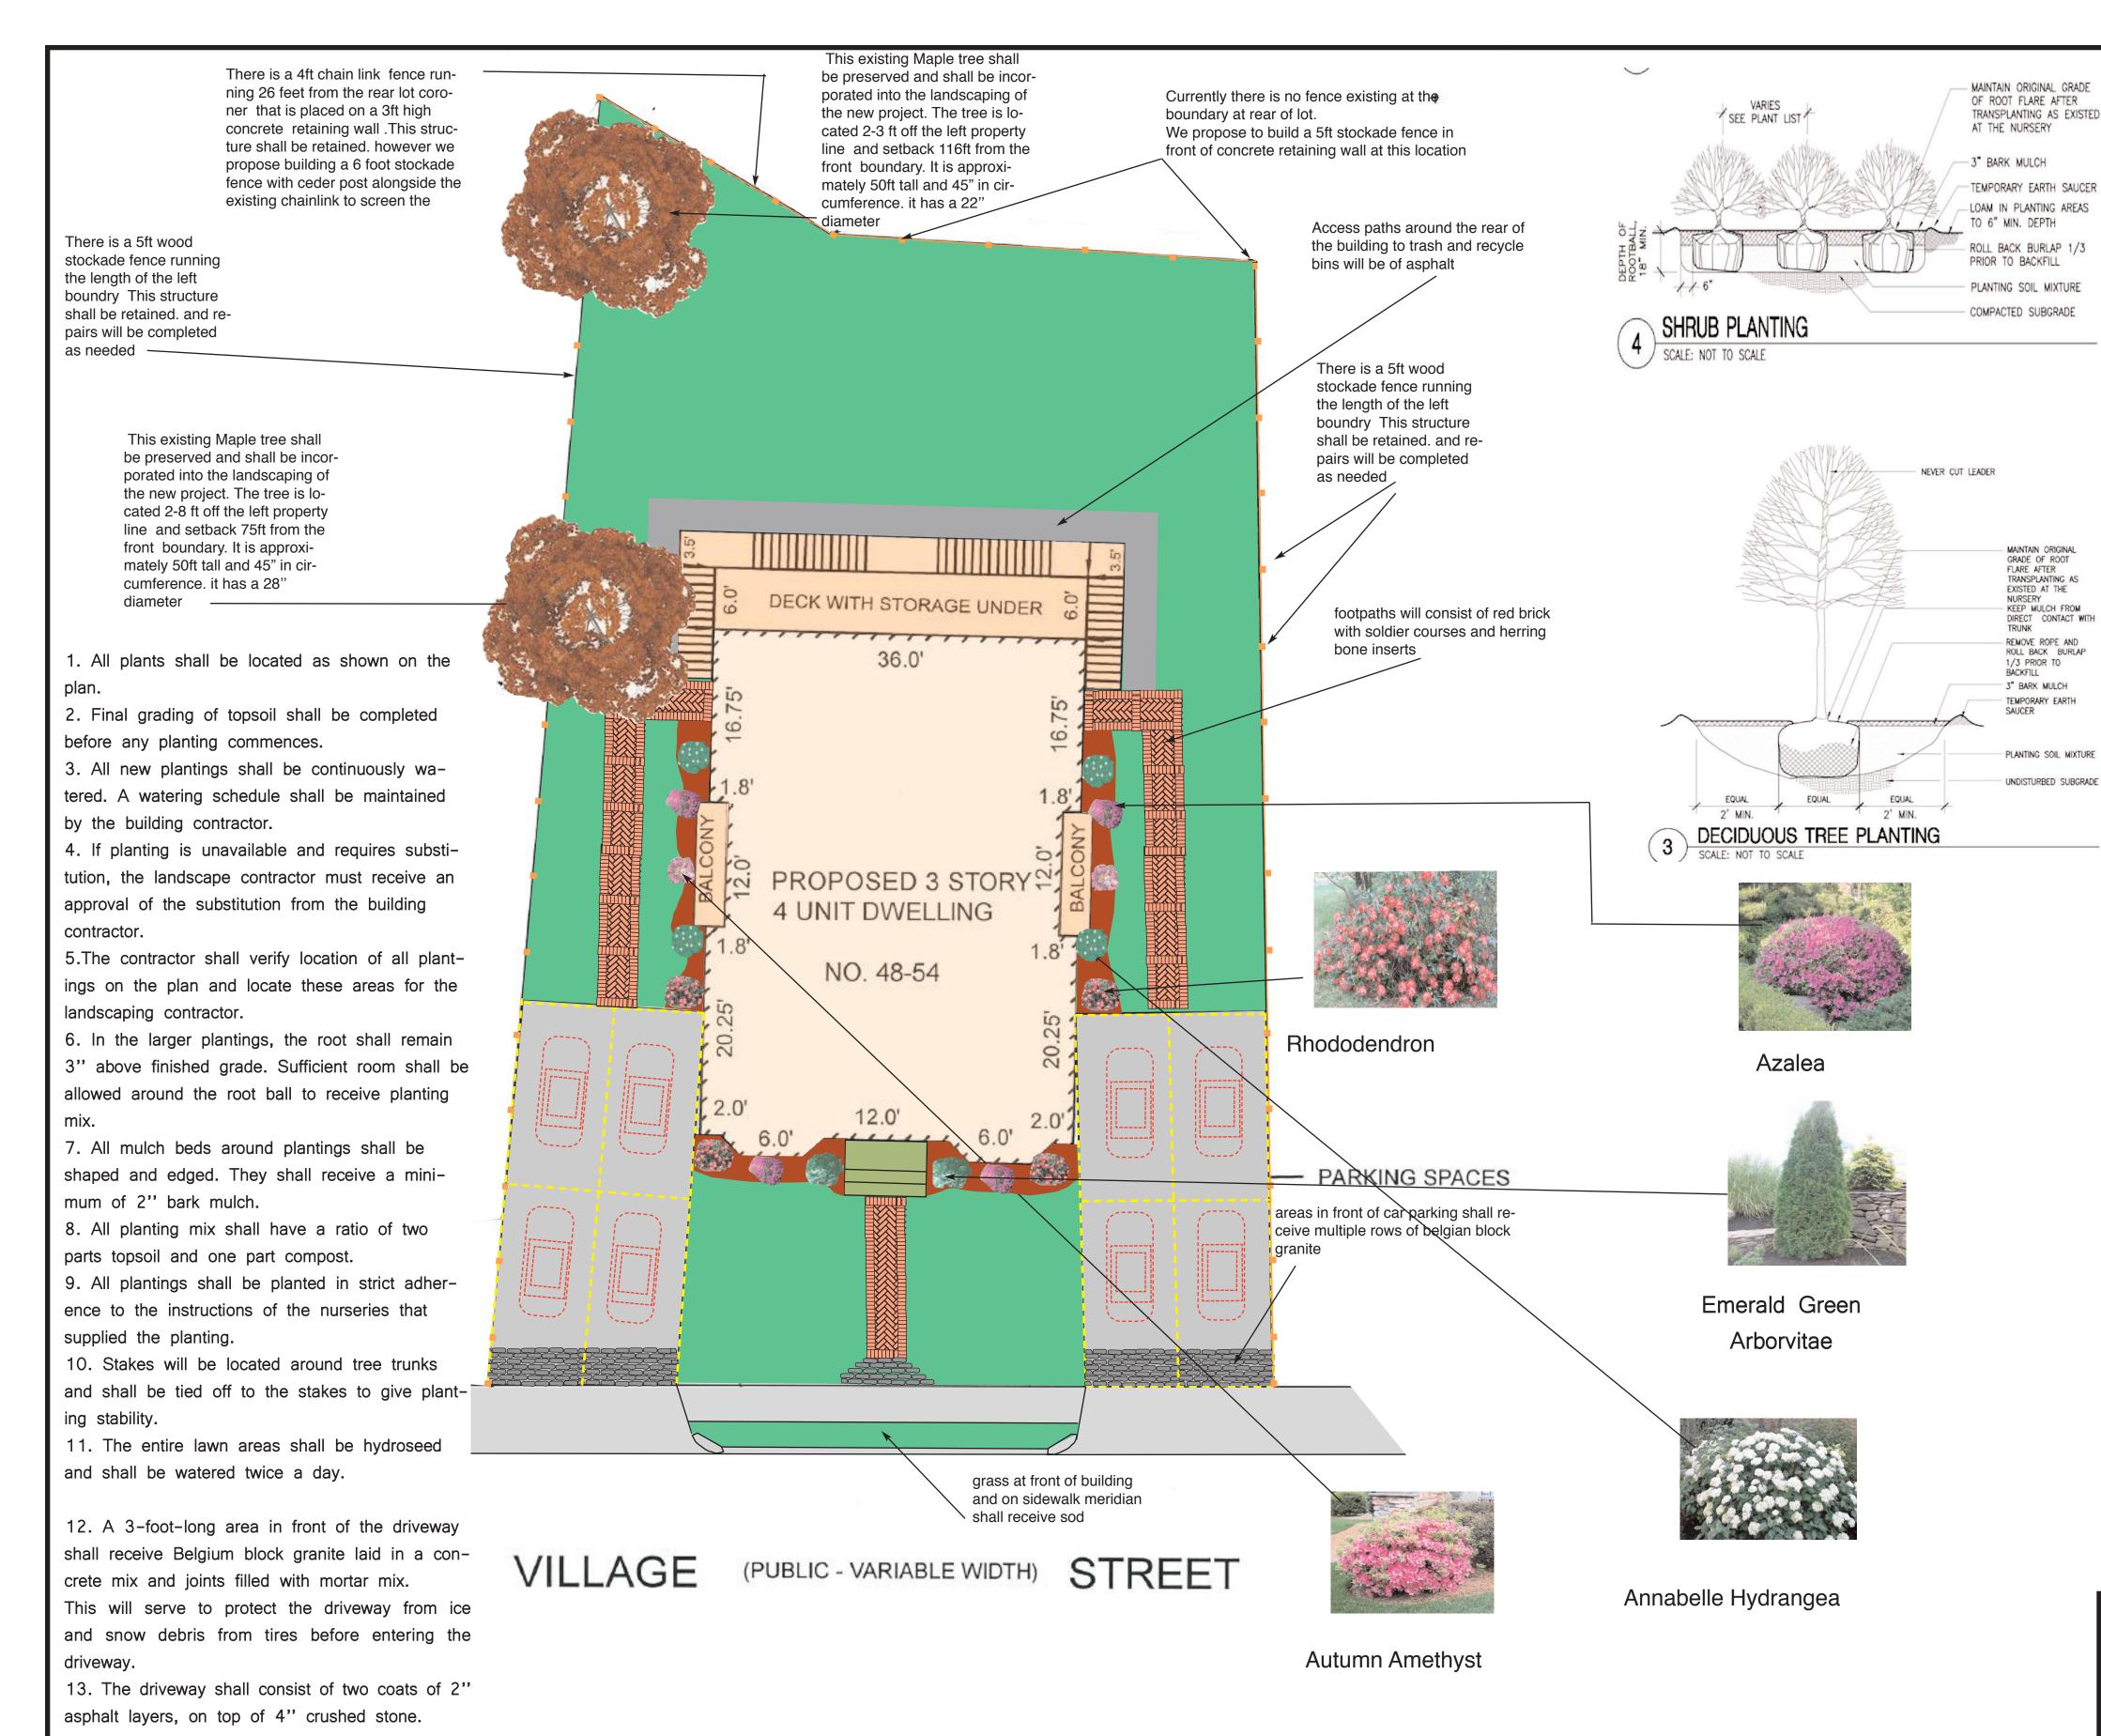

Key	Quantity	Scientific Name	Common Name	Size
A1	4	Hydrangea Arborescens	Annabelle Hydrangea	30"
A2	2	Thuja Occidentalis	Emerald Arborvitae	7'-8' ht
A3	2	Azalea X Amethyst	Autumn Amethyst	4' ht
A4	4	R. ferrugineum	Rhododendron	A3' ht
A5	4	Rhododendron family Ericaceae	Azalea	3' ht

Annabelle

Stunning white hydrangea, Annabelle often producing heads over 10" in diameter. Unlike the better known blue and pink hydrangeas (macrophyllous), Annabelle blooms every year even after severe pruning or intensely cold winters. This huge, white "drumstick" blooms appear in profusion without fail.

Emerald Arborvitae

Narrow, pyramidal evergreen displaying dense emerald green foliage. Holds its foliage color throughout winter. Excellent medium to large hedge or screening plant. Moderate grower to 15 ft. tall, 3-4 ft. wide. needs full sun. requires less water once established

Autum Amethyst

Plant Description: Attractive purple foliage in the winter and stunning purple blooms in spring, summer, and fall.

Bloom Description: Dark lavender, single form blooms measure 2" across. (The Autum Amethyst is an attractive flower with purple foliage in the winter, and stunning a stunning purple that blooms in the spring, summer, and fall. The blooming is dark lavender, in which single form blooms measure up to 2" across.)


Rhododendron

Rhododendrons are some of the easiest, most rewarding flowering shrubs for the sunny to partly shaded garden. The huge clusters of bright, colorful flowers bloom heavily for weeks. Rhododendrons are great for use along foundations, and along garden or lawn borders and are available in all colors., Rhododendrons are actually hardy for all but the coldest regions of the country.

Azalea

Are flowering shrubs Azaleas bloom in spring, their flowers often lasting several weeks. They are generally slow-growing and do best in well-drained acidic soil Shade tolerant, they prefer living near or under trees.

48-54 Village Street Reading Illustrative landscape plan November 3rd, 2022

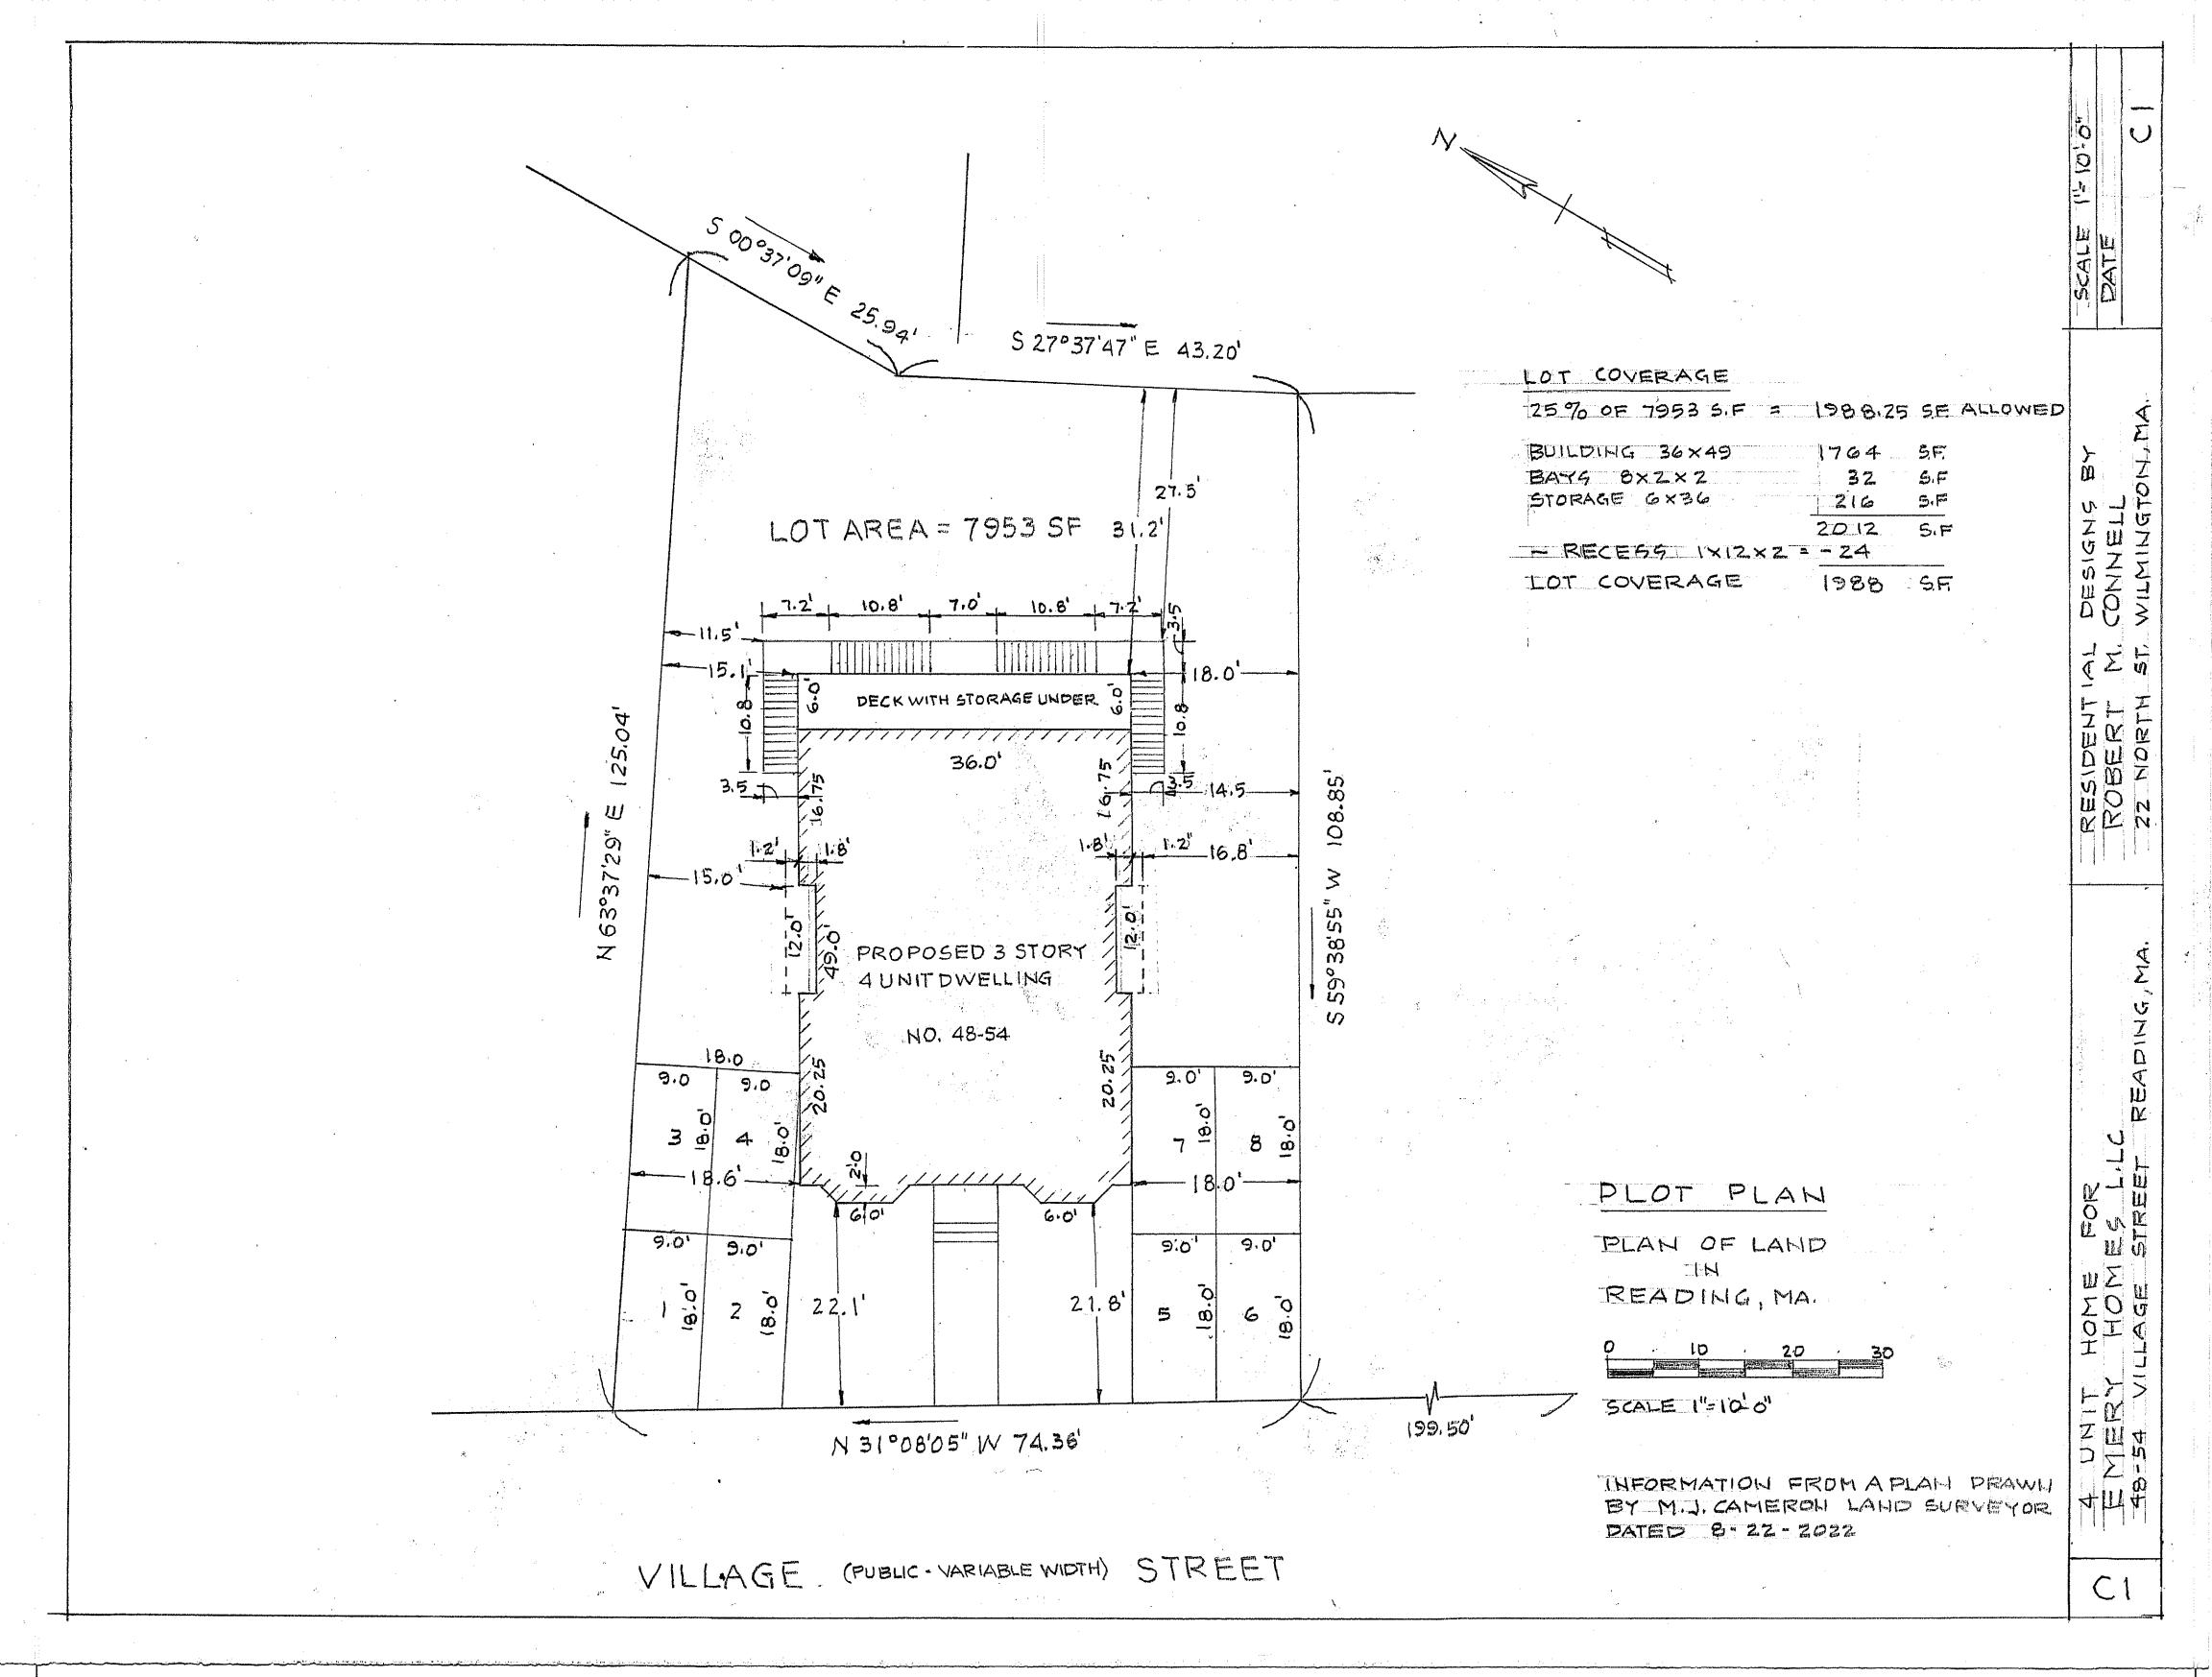



FRONT ELEVATION

SCALE 4"=1"0"

ROBERT M. CONNELL
22 NORTH SP. WILMINGTON, MA.

THE TOWE FOR LICE TO THE TOWNER OF THE STREET READING, MA,

AI



SIDE

DE ELEVA

RIGHT

CONNELL WILMINGTON, MA

READING, MA,

FAMILY HOME FOR IERY HOMES LLE 54 VILLAGE STREET

A2



CONNELL T. WILMINGTON, MA.

READING, MA.

A FAMILY HOME FOR EMERY HOMES LLC

A3

ELEVATION REAR





SCALE 14"51:0" CONNIELL WILMINGTON , MA. READING, MA 4 FAMILY HOME FOR FMERY HOMES L.L. 48-54 VILLAGE STREET


A4

LEFT SIDE ELEVATION

SCALE 4'= 1'0'

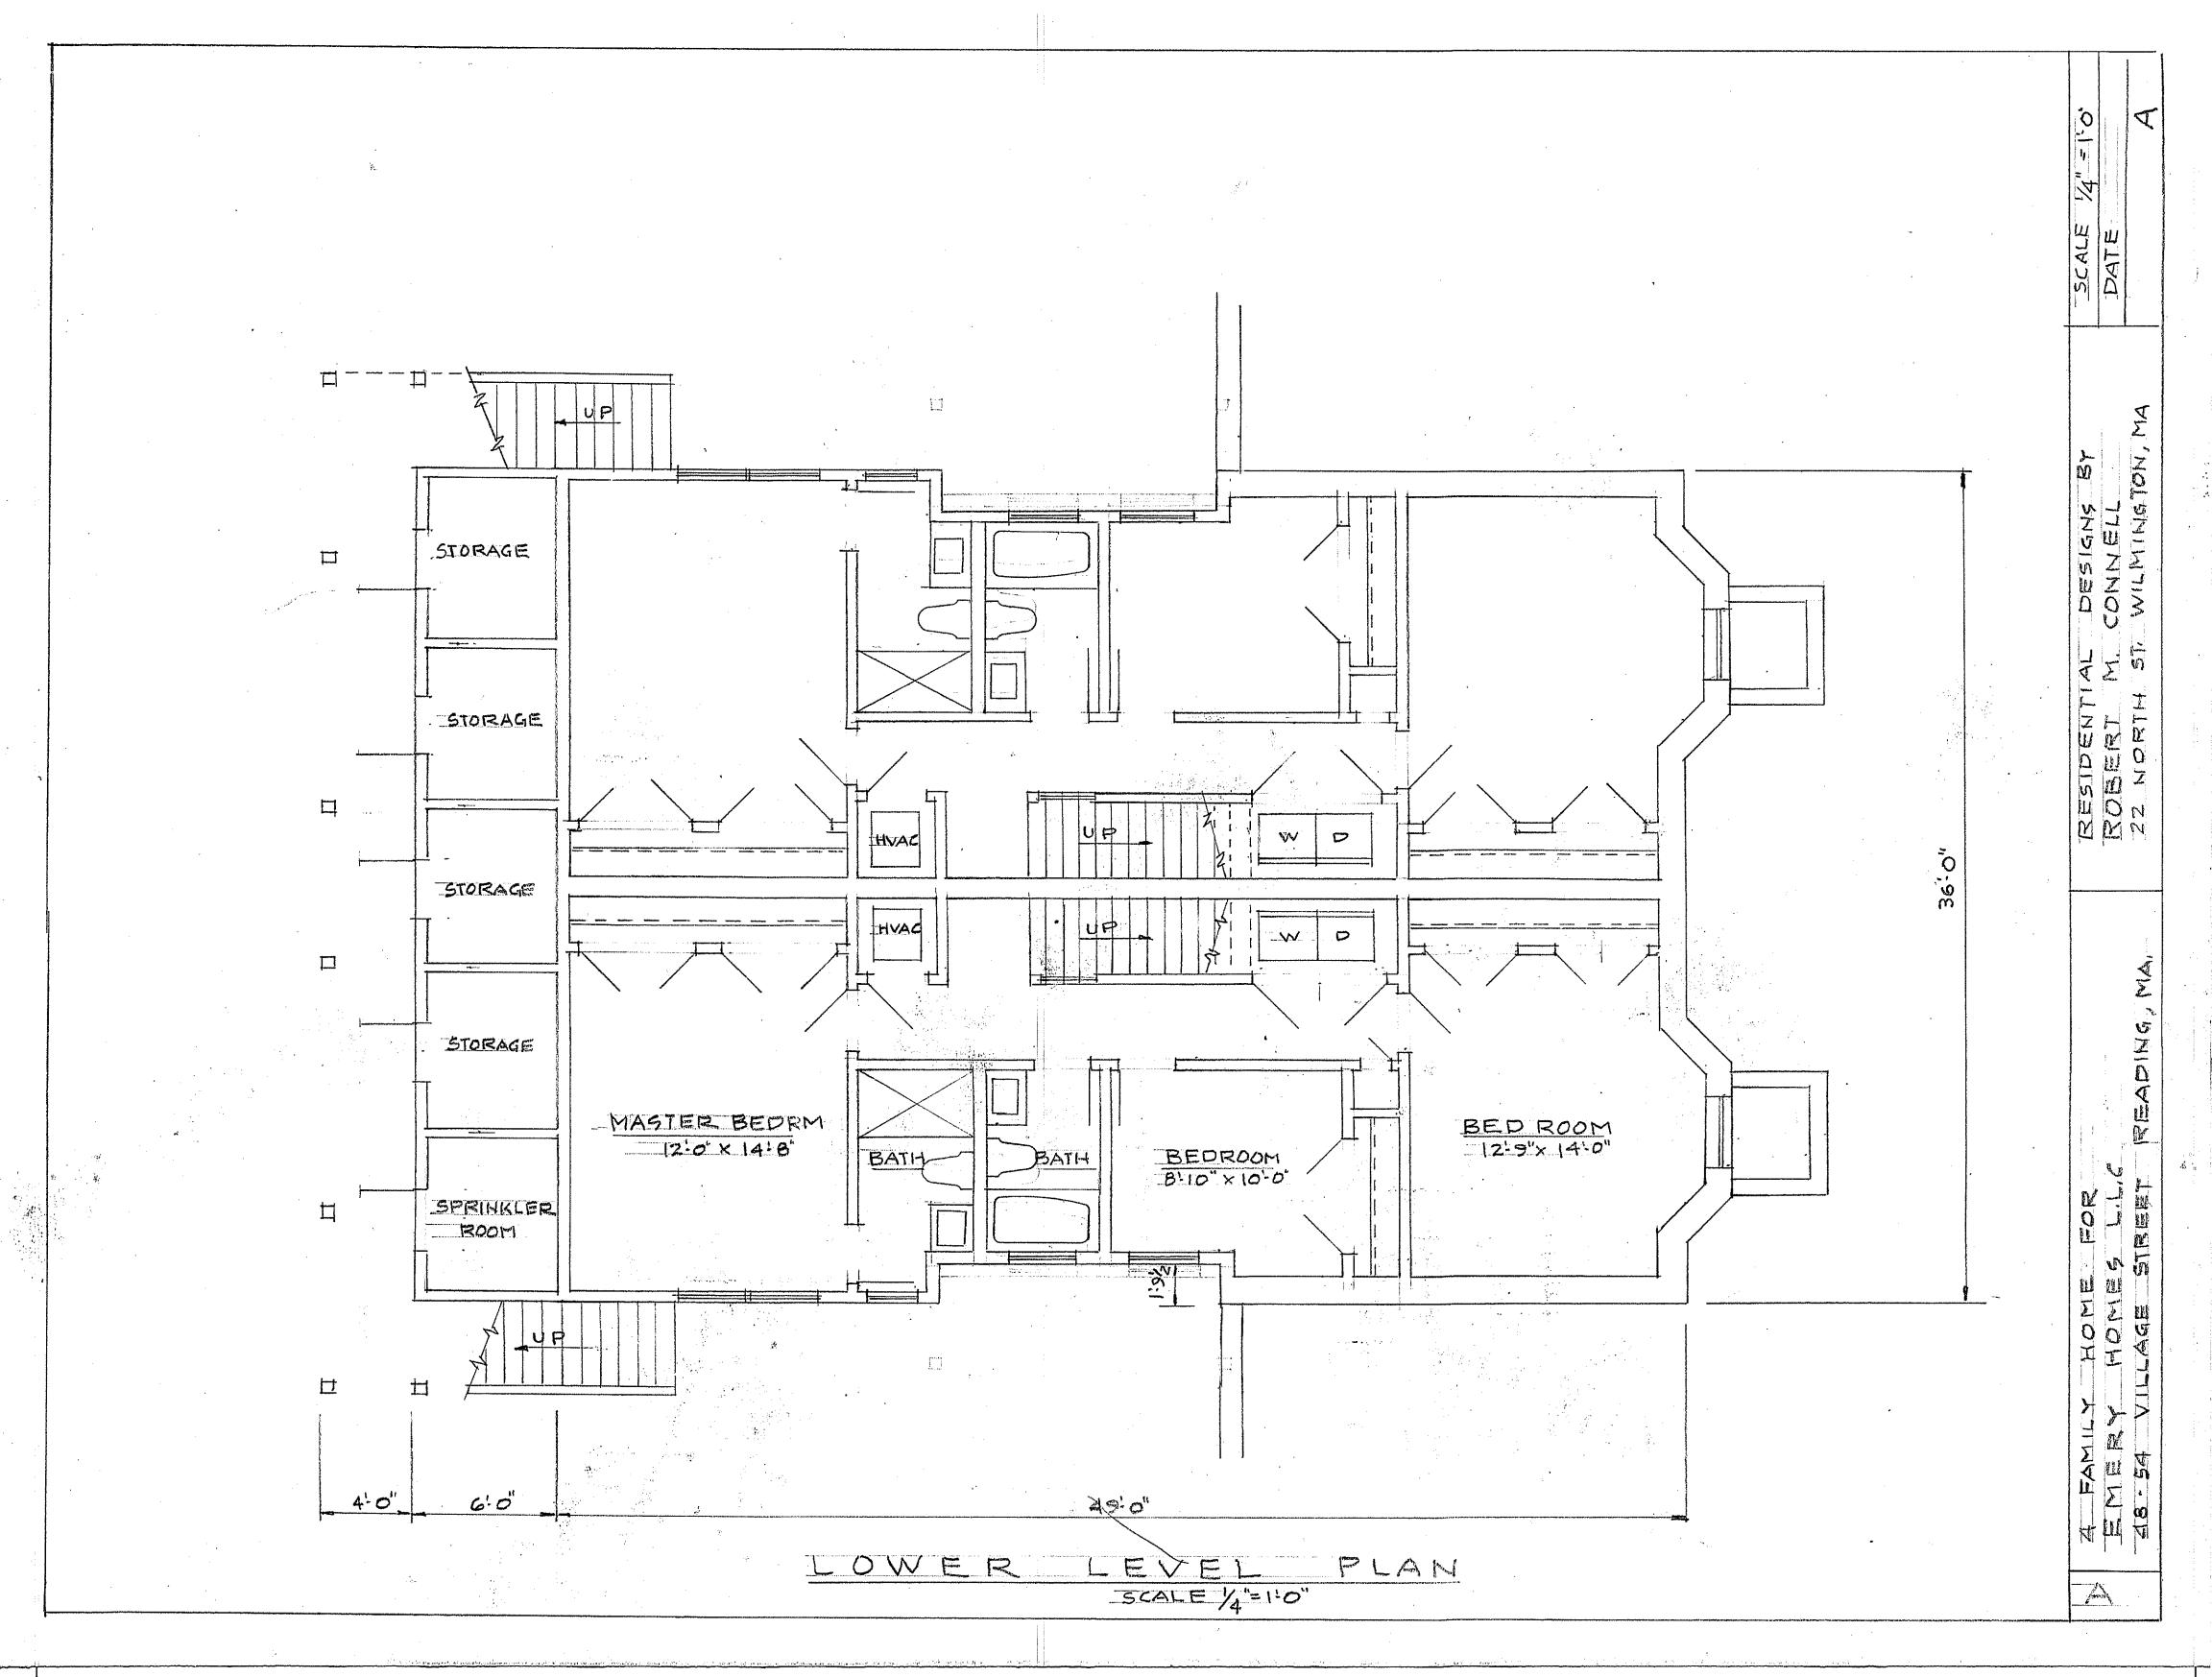

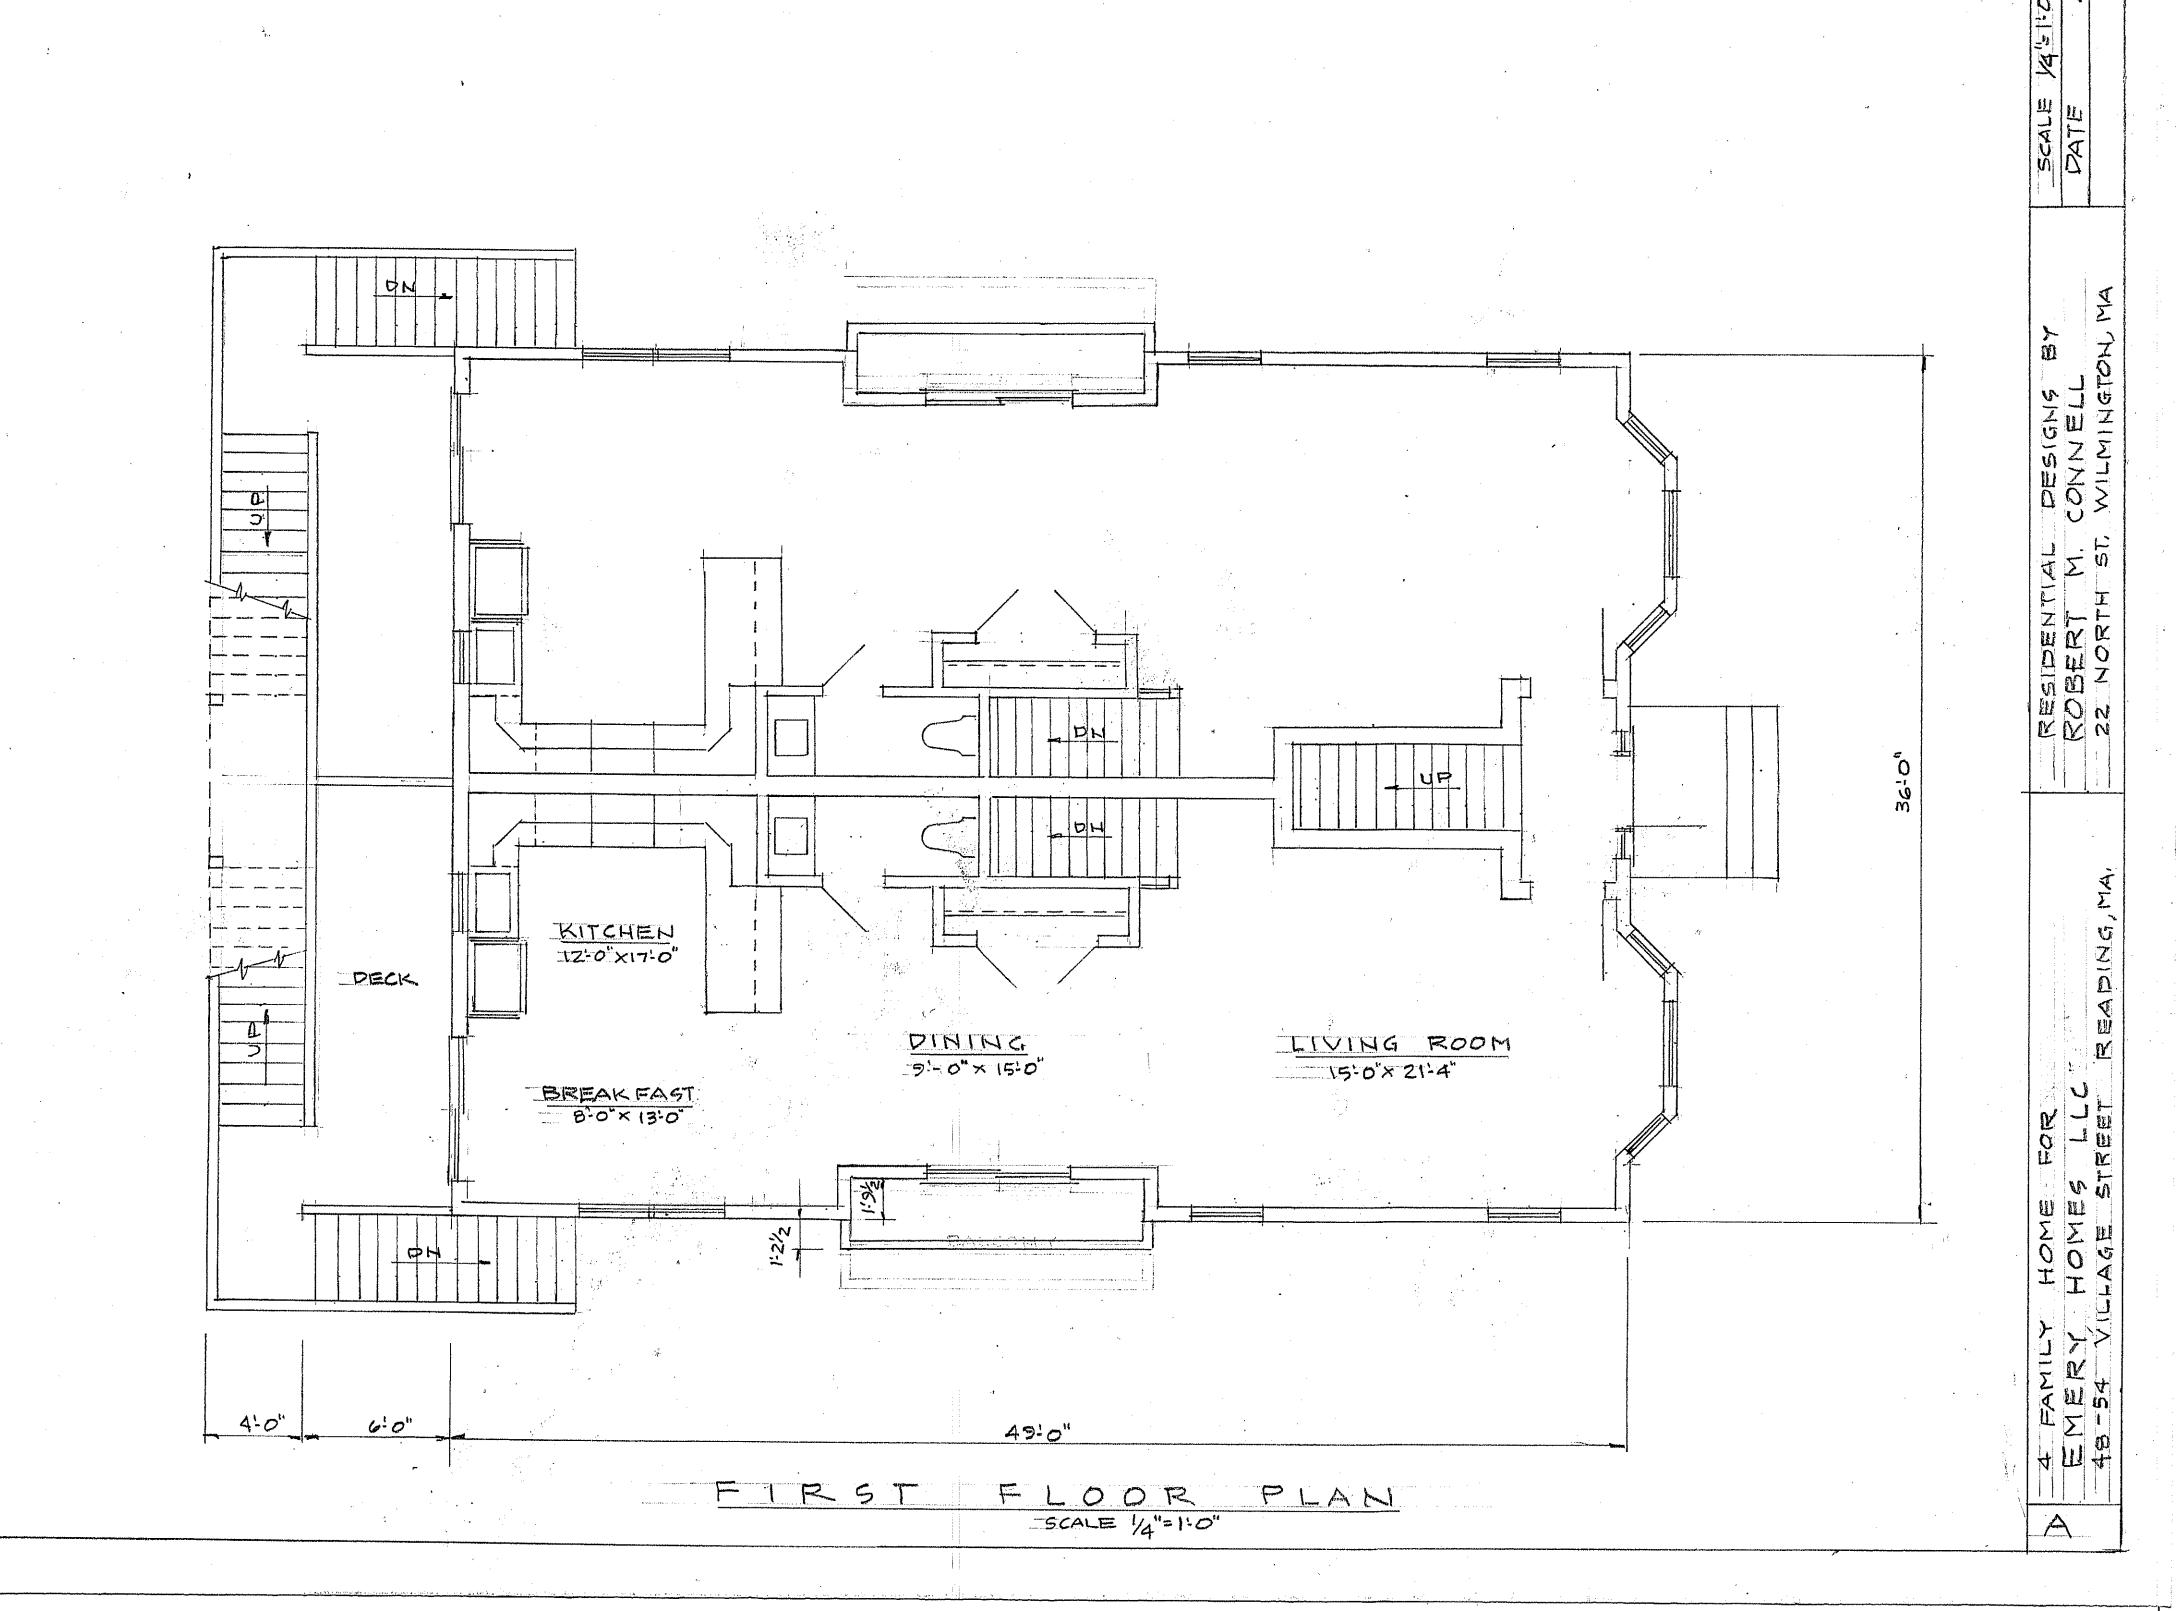

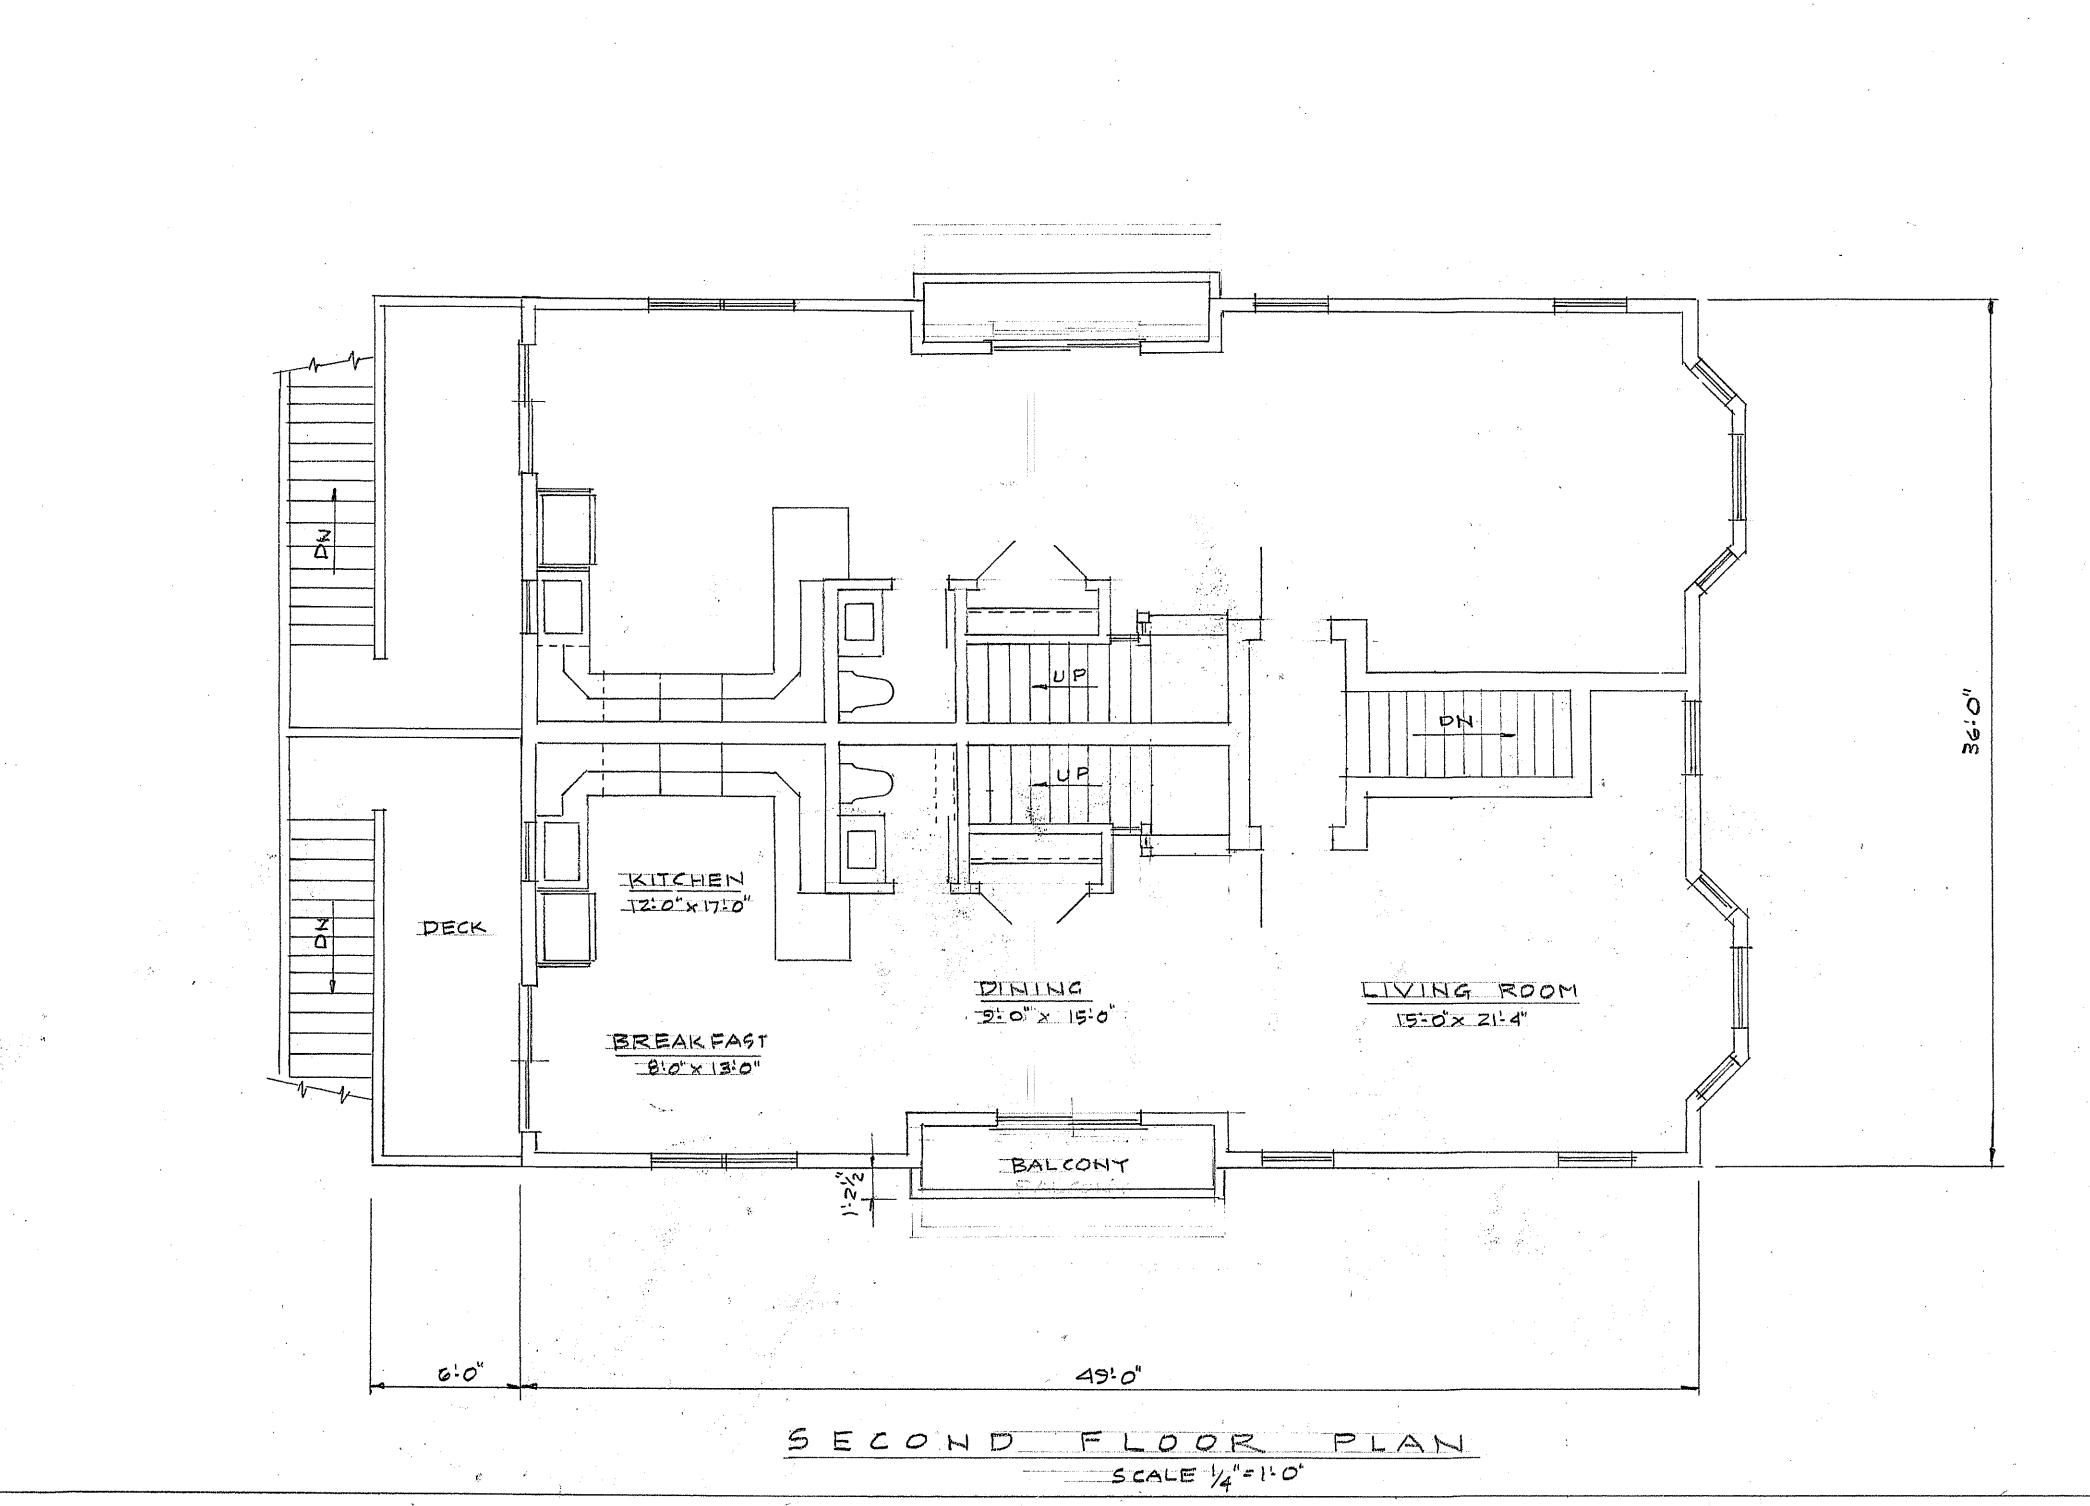


CONNELL WILMINGTON MA RESIDENTIAL ROBERT M. 22 NORTH ST.

SCALE

READING MA 25

LY HOME Y HOMES VILLAGE 4 FAMILY EMERY 48-54 VII


A

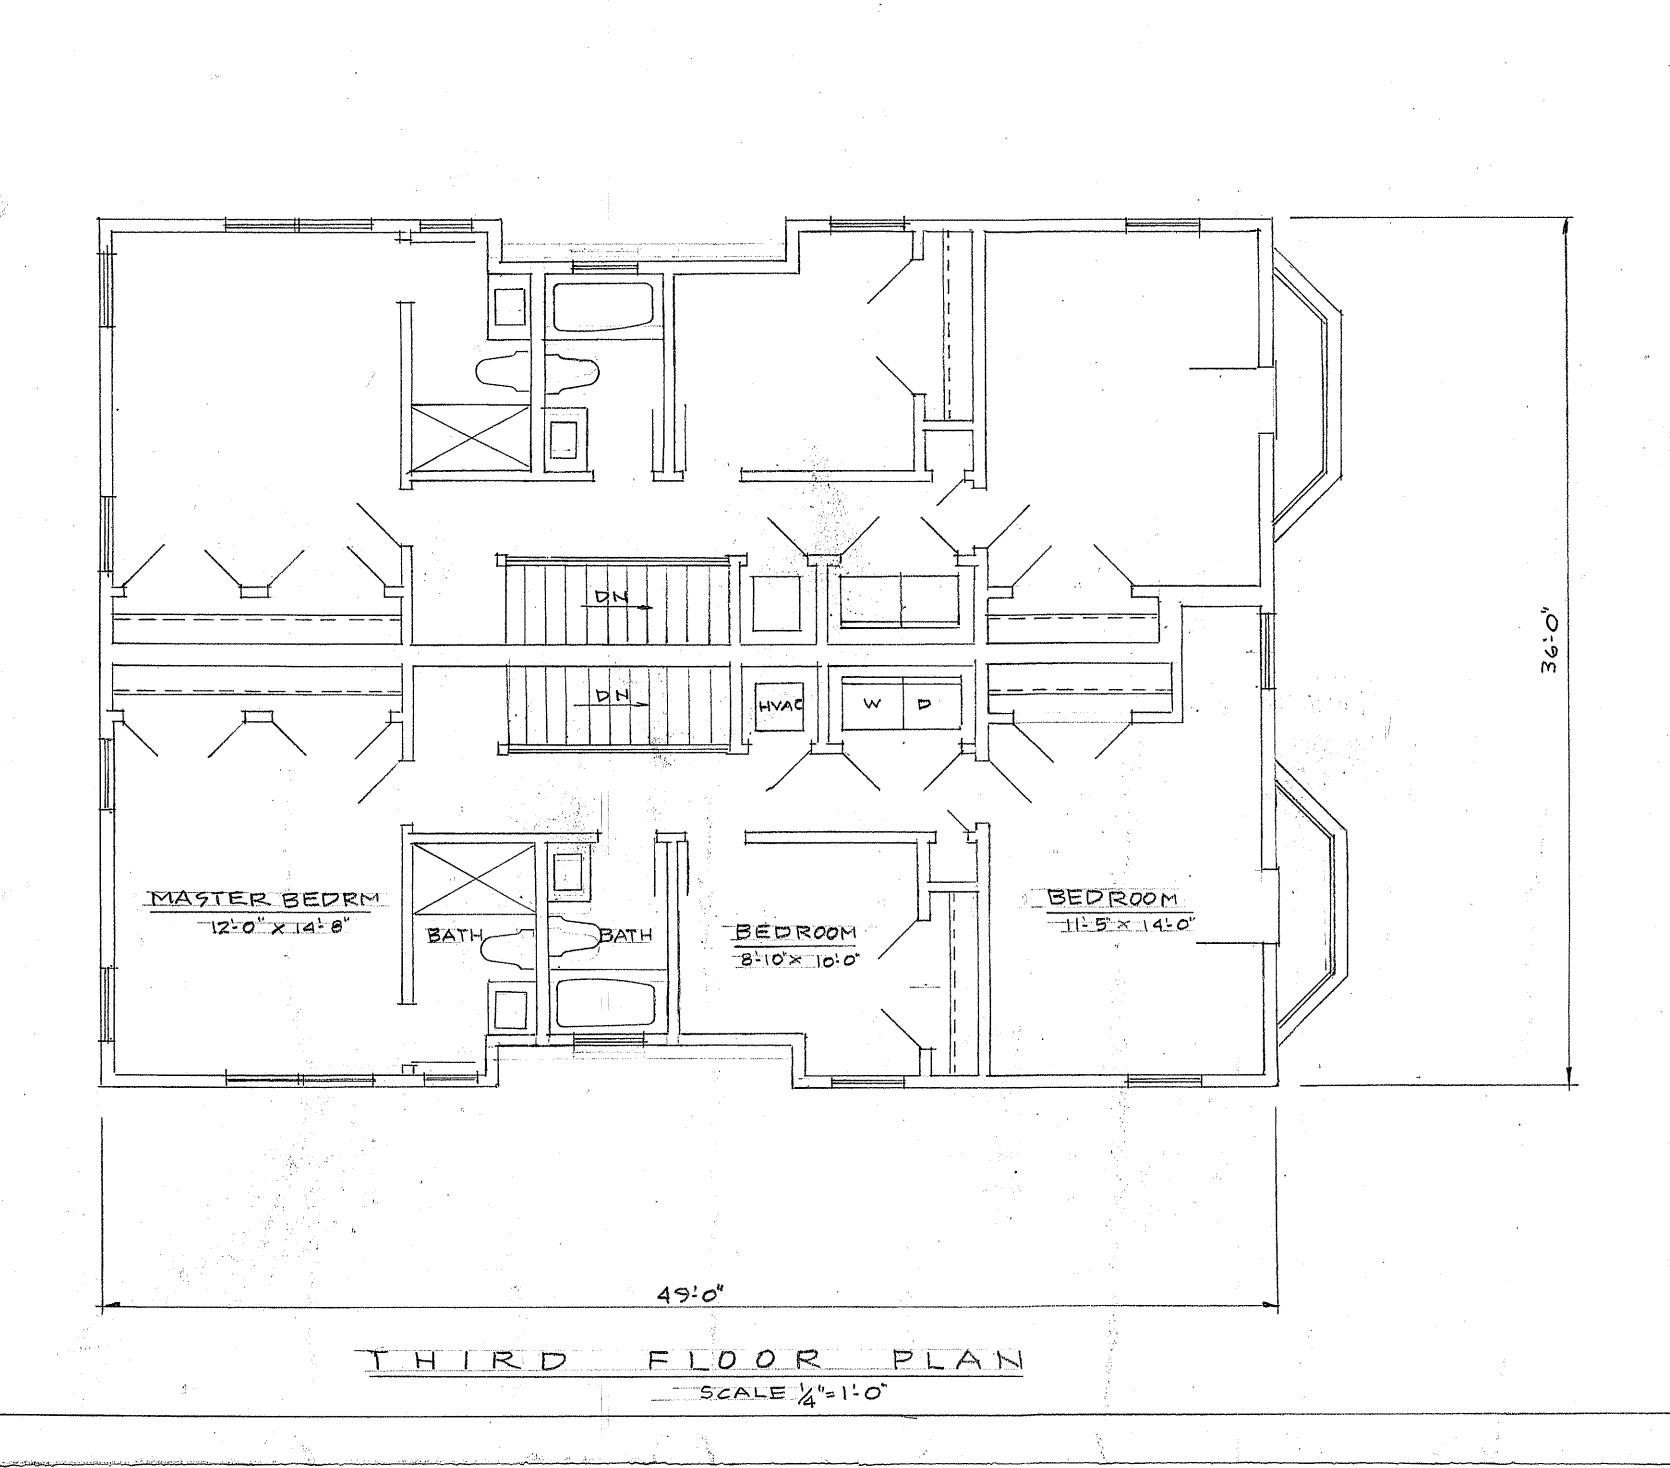

RESIDENTIAL DESIGNS BY
ROBERT M. CONNELL
22 NORTH ST. WILMINGTON, MA,

4 FAMILY HOME FOR EMERY HOMES LLC. 48-54 VILLAGE ST. READING, MA

A

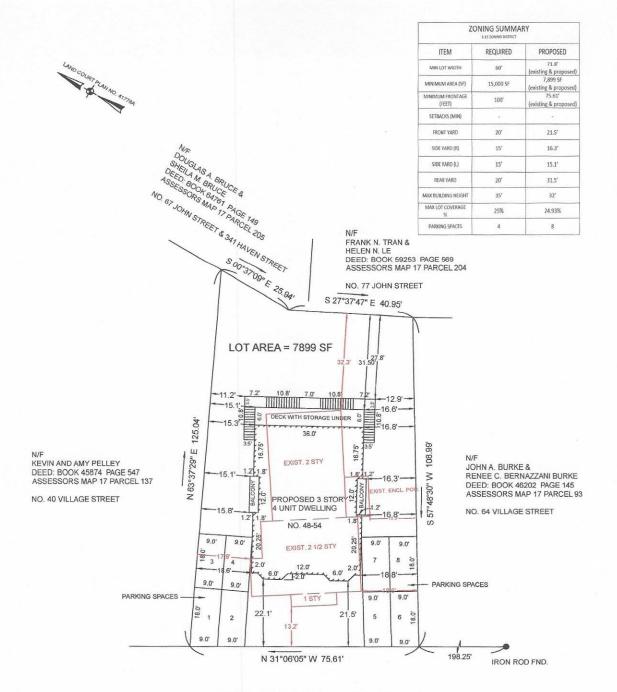

VILLAGE (PUBLIC - VARIABLE WIDTH) STREET

NOTES

- 1.) THIS PLAN WAS PREPARED FROM AN INSTRUMENT SURVEY
- 2.) RECORD OWNERS: 48 VILLAGE STREET, LLC
- 3.) DEED REFERENCE: BOOK 80153 PAGE 279
- 3.) ASSESSORS PLAN 17 PARCEL 192
- 4.) ZONING DISTRICT: S 15
- 5.) BUILDING COVERAGE: 1969 SF/7899 SF = 24.93%

PLOT PLAN

SHOWING PROPOSED 4 UNIT DWELLING

IN

READING, MA

48-54 VILLAGE STREET



SCALE: 1" - 20'-0"

SEPTEMBER 5, 2022

D & A SURVEY ASSOCIATES, INC. P.O. BOX 621 MEDFORD, MA 02155 (781) 324 - 9566

NO. 67-JOHN STREET & 347 HAVEN STREET SHELLAGA, BRUCKER SEELAM, BRUCKCER SEELOW, MAD 17 ACK 17 ACK 17 ACK 18 AC \$00037,000,000 S 27°37'47" E 40.95 N/F FRANK N. TRAN & HELEN N. LE DEED: BOOK 59253 PAGE 569 ASSESSORS MAP 17 PARCEL 204 NO. 77 JOHN STREET

NO. 40 VILLAGE STREET

N/F KEVIN AND AMY PELLEY DEED: BOOK 45874 PAGE 547 ASSESSORS MAP 17 PARCEL 137

-11.2' -15.1' -15.3'

DECK WITH STORAGE UNDER 6

10.8'

12.9

LOT AREA = 7899 SF

3

N 63°37'29" E 125.04' BALCONY 12.0' 1.8 20.25 ·00 PROPOSED 3 STORY 22 NO. 48-54 20.25 BALCONY 16.8 9.0' S 57°48'30" W 108.99"

N/F
JOHN A. BURKE &
RENEE C. BERNAZZANI BURKE
DEED: BOOK 46202 PAGE 145
ASSESSORS MAP 17 PARCEL 93

NO. 64 VILLAGE STREET

PARKING SPACES

9.0'

ω

2.0

 ∞ œ

PARKING SPACES

18.0'

18.0'

2

Ω

5

6

18.0'

VILLAGE (PUBLIC - VARIABLE WIDTH) STREET

N 31°06'05" W 75.60'

198.25

IRON ROD FND.

MICHAEL J CAMERON NO. 56742 48-54

NOTES:
1.) THIS PLAN WAS PREPARED FROM AN INSTRUMENT SURVEY

SHOWING PROPOSED **4 UNIT DWELLING** PLOT PLAN

DING, AGE 20 M N 40

STREET

SEPTEMBER 5, SCALE: 1" - 20'-0" 2022

D & A SURVEY ASSOCIATES, INC. P.O. BOX 621 MEDFORD, MA 02155 (781) 324 - 9566

5.) BUILDING COVERAGE: 1969 SF/7899 SF = 24.93%


4.) ZONING DISTRICT: S - 15

3.) ASSESSORS PLAN 17 PARCEL 192

3.) DEED REFERENCE: BOOK 80153 PAGE 279

2.) RECORD OWNERS: 48 VILLAGE STREET, LLC



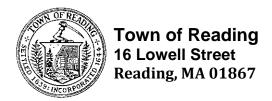

Andrew MacNichol Senior Planner Phone: 781.942-6670

Fax: 781.942-9071

Website: www.readingma.gov

November 7, 2022

Minor Site Plan Review DECISION

Project/Site: 581-591 Main Street

To the Town Clerk:

This is to certify that, at a meeting of the Community Planning and Development Commission opened on October 17, 2022, and closed on November 7, 2022, by a motion duly made and seconded, it was voted:

"We, the Reading Community Planning and Development Commission, upon request from Chris Greogoris, for Minor Site Plan Review for the property located at 581-591 Main Street (Assessors Map 17, Lot 184) for exterior renovations to the building, as presented in the application materials enumerated below, do hereby vote XXX, to ______the project under Minor Site Plan Review in accordance with Section 4.6.3 of the Reading Zoning Bylaw, subject to the Findings and Conditions below."

Materials Submitted:

The following materials were submitted into the public record:

- 1. Certified Abutters List, dated 9/15/22;
- 2. Minor Site Plan Review Courtesy Notice of Public Meeting to Abutters, delivered;
- 3. Project Description, dated 4/7/22;
- 4. Building Section(s) for Alteration, received 9/12/22;
- 5. Architectural Plan Set, prepared by H Arch Collaborative, prepared for 583 Main Street, Reading, MA, Masonry Work, dated 8/22/22 and consisting of:
 - a. Sheet A0.1: Existing Elevation
 - b. Sheet A0.2: Proposed Elevation
 - c. Sheet A0.3: Section Detail
- Plot Plan of Land, prepared by RJ O'Connell & Associates, Inc., prepared for JMS Masonry and Restoration, LLC, 581-591 Main Street/231-239 Haven Street, Reading, MA, 01867, dated 6/10/22;
- 7. Pedestrian Access and Scaffolding Plan, received 9/12/22;
- 8. Email from Reading Historical Commission, dated 10/31/22;
- 9. Applicant Response to Reading Historical Commission, dated 11/2/22;
- 10. Draft Decision, dated 11/7/22;

Findings:

- 1) Applicability: The proposed work requires Minor Site Plan Review approval under Zoning Bylaw Section 4.6.2.3(d), "Exterior alteration of 500 square feet or more of horizontal or vertical area that is limited to doors, paint, awnings, railings, step replacement, handicapped ramps or building code compliance measures, for a site within the Business B Zoning District"
- Site/Zoning: The site is multi-tenant single-story commercial building with units addressed through 581-591 Main Street and 231-239 Haven Street. It is located at the corner of Main Street and Haven Street and is within the Business-B Zoning District.
- 3) Historic: The structure is included on the Town of Reading's Local Historical Inventory list.
- 4) Overview:
 - a. Existing Structure: The existing concrete roof/parapet of the building is in disrepair and in need of removal/replacement. The existing roof/parapet measures 6' in height and wraps from the south of the building to the corner of Main Street and Haven Street. It does not continue to the east down Haven Street.
 - b. <u>Proposed Work</u>: New masonry brick work is proposed to replace the concrete parapet. The brick masonry will measure 3'9" in height and include a 6.5" parapet for total height of 4'3.5"; which matches the height of the existing Haven Street building facade and total building height of 15'. It will be capped with bluestone material.
- 5) <u>Scaffolding and Pedestrian Access</u>: As the removal and replacement of the parapet/roof ensues walkthrough framing and staging will be utilized along the building west façade fronting Main Street. The walkthrough staging will maintain ADA compliance and will be covered above to prevent debris on the sidewalk. Pedestrian access to businesses within the site, and abutting the site, shall not be impeded. Lighting shall be utilized within the framing.

Conditions:

General:

- 1. **Limitations / Future Uses:** The Decision herein does not include approval for any future uses or site renovations that may on their own merits and design trigger the requirements of future site plan review, and/or require a special permit.
- 2. Public Health, Safety and Welfare: If, at any time, the site becomes a nuisance to public health, safety or welfare (i.e., traffic spillover, excessive noise, unreasonable site illumination beyond the hours of operation, etc.) as shall be evidenced by substantiated complaints to the Police Department or Public Services Office the Applicant/Owner shall agree to work with staff to rectify the problem. Should the situation warrant it, an additional Site Plan Review by the CPDC may be required.
- 3. **Signage:** No site identification signage is approved with this application. The Applicant shall submit a Sign Permit Application, for review and approval by the Community Development Director, prior to installing any non-directional or ADA signage.
- 4. **Permitting:** The approval herein is for Minor Site Plan Review only. The Applicant shall seek building, electrical, plumbing, and gas permits as needed for the work.

During Construction:

- 1. Preservation of Historic Elements:
 - a) The Applicant and/or Contractor shall preserve and maintain all of the existing urn (4) and medallion (2) elements above/within the building parapet when removal occurs.
 - b) The concrete pilasters shall be preserved in place when re-pointing.
- Construction Hours: Construction shall be limited to the hours specified in General Bylaw Section 8.9.8.
- 3. Construction Activities: Construction activities shall be conducted in a workmanlike manner at all times. Blowing dust or debris shall be controlled by the Applicant through stabilization, wetting down, and proper storage and disposal methods, subject to the approval of the Health Agent or designee. The Applicant shall ensure that the abutting local streets are kept clear of dirt and debris, which may accumulate as a result of construction activities for the Project. Documentation shall be provided demonstrating ongoing pest management control, subject to the approval of and administration by the Health Agent.
- 4. **Site Inspections:** Town staff or their designee shall have reasonable access to inspect the site to determine compliance with this Decision.
- 5. **Lighting:** Light fixtures shall be installed/adjusted to minimize impacts on traffic.
- 6. **Architecture:** The building façade on each elevation (north, south, east, and west) shall be substantially as indicated on the approved plans and elevations.

<u>Modifications/Revisions - Plan Changes after Approval by the Approving Authority:</u> Contemplated future changes to the plan approved herein shall be presented to the Community

Development Director and the Zoning Enforcement Officer/Building Inspector, or other relevant Town staff, for review prior to implementation of proposed changes.

- 1. Minor Modification: Changes that do not substantially alter the concept of the approved Plan in terms of the specific location, the proposed land use, the design of building form and approved building details and materials, site grading or egress points. These include but are not limited to small changes in site layout, topography, architectural plans, landscaping plan, traffic circulation, parking, lighting, signage, open space or other criteria set forth in Section 4.6.9.1. Requests for approval under a minor modification for future renovations/alterations to the approved site plan or for future tenant changes shall be reviewed by the Community Development Director to determine if the proposed work qualifies for review through the Minor Site Plan Review process of Section 4.6.3 of the Reading Zoning Bylaw. If the work is eligible for review under Minor Site Plan review, the Community Development Director may review and grant approval of the proposed work by administrative approval of the Minor Modification. At the determination of the Community Development Director, the Applicant may be required to present the proposed project at a public meeting of the CPDC.
- **2. Major Modification:** Substantial additions, deletions or deviations from the approved plan, including but not limited to changes in site layout, topography, architectural plan, landscaping plans, traffic circulation, parking, lighting plan, signage, open space or other criteria set forth in Section 4.6.9.1 of the Reading Zoning Bylaw. (Note: Approval of the major modification shall be grounds for reconsideration of the Site Plan application. Denial of proposed major modifications shall not invalidate the Site Plan in conformance with the previously approved Plan).

Commented [MA1]: Is there any interest in a partnership to deliver to Town Hall/RHC? Is RHC interested in such?

Commented [MA2R1]: How do we tie this to any permitting closing?


Signed as to the accuracy of the vote as reflected in the minutes:


Andrew MacNichol, Senior Planner

Date

Cc: Applicant, Town Clerk, CPDC, Development Review Team, Building Inspector, planning file



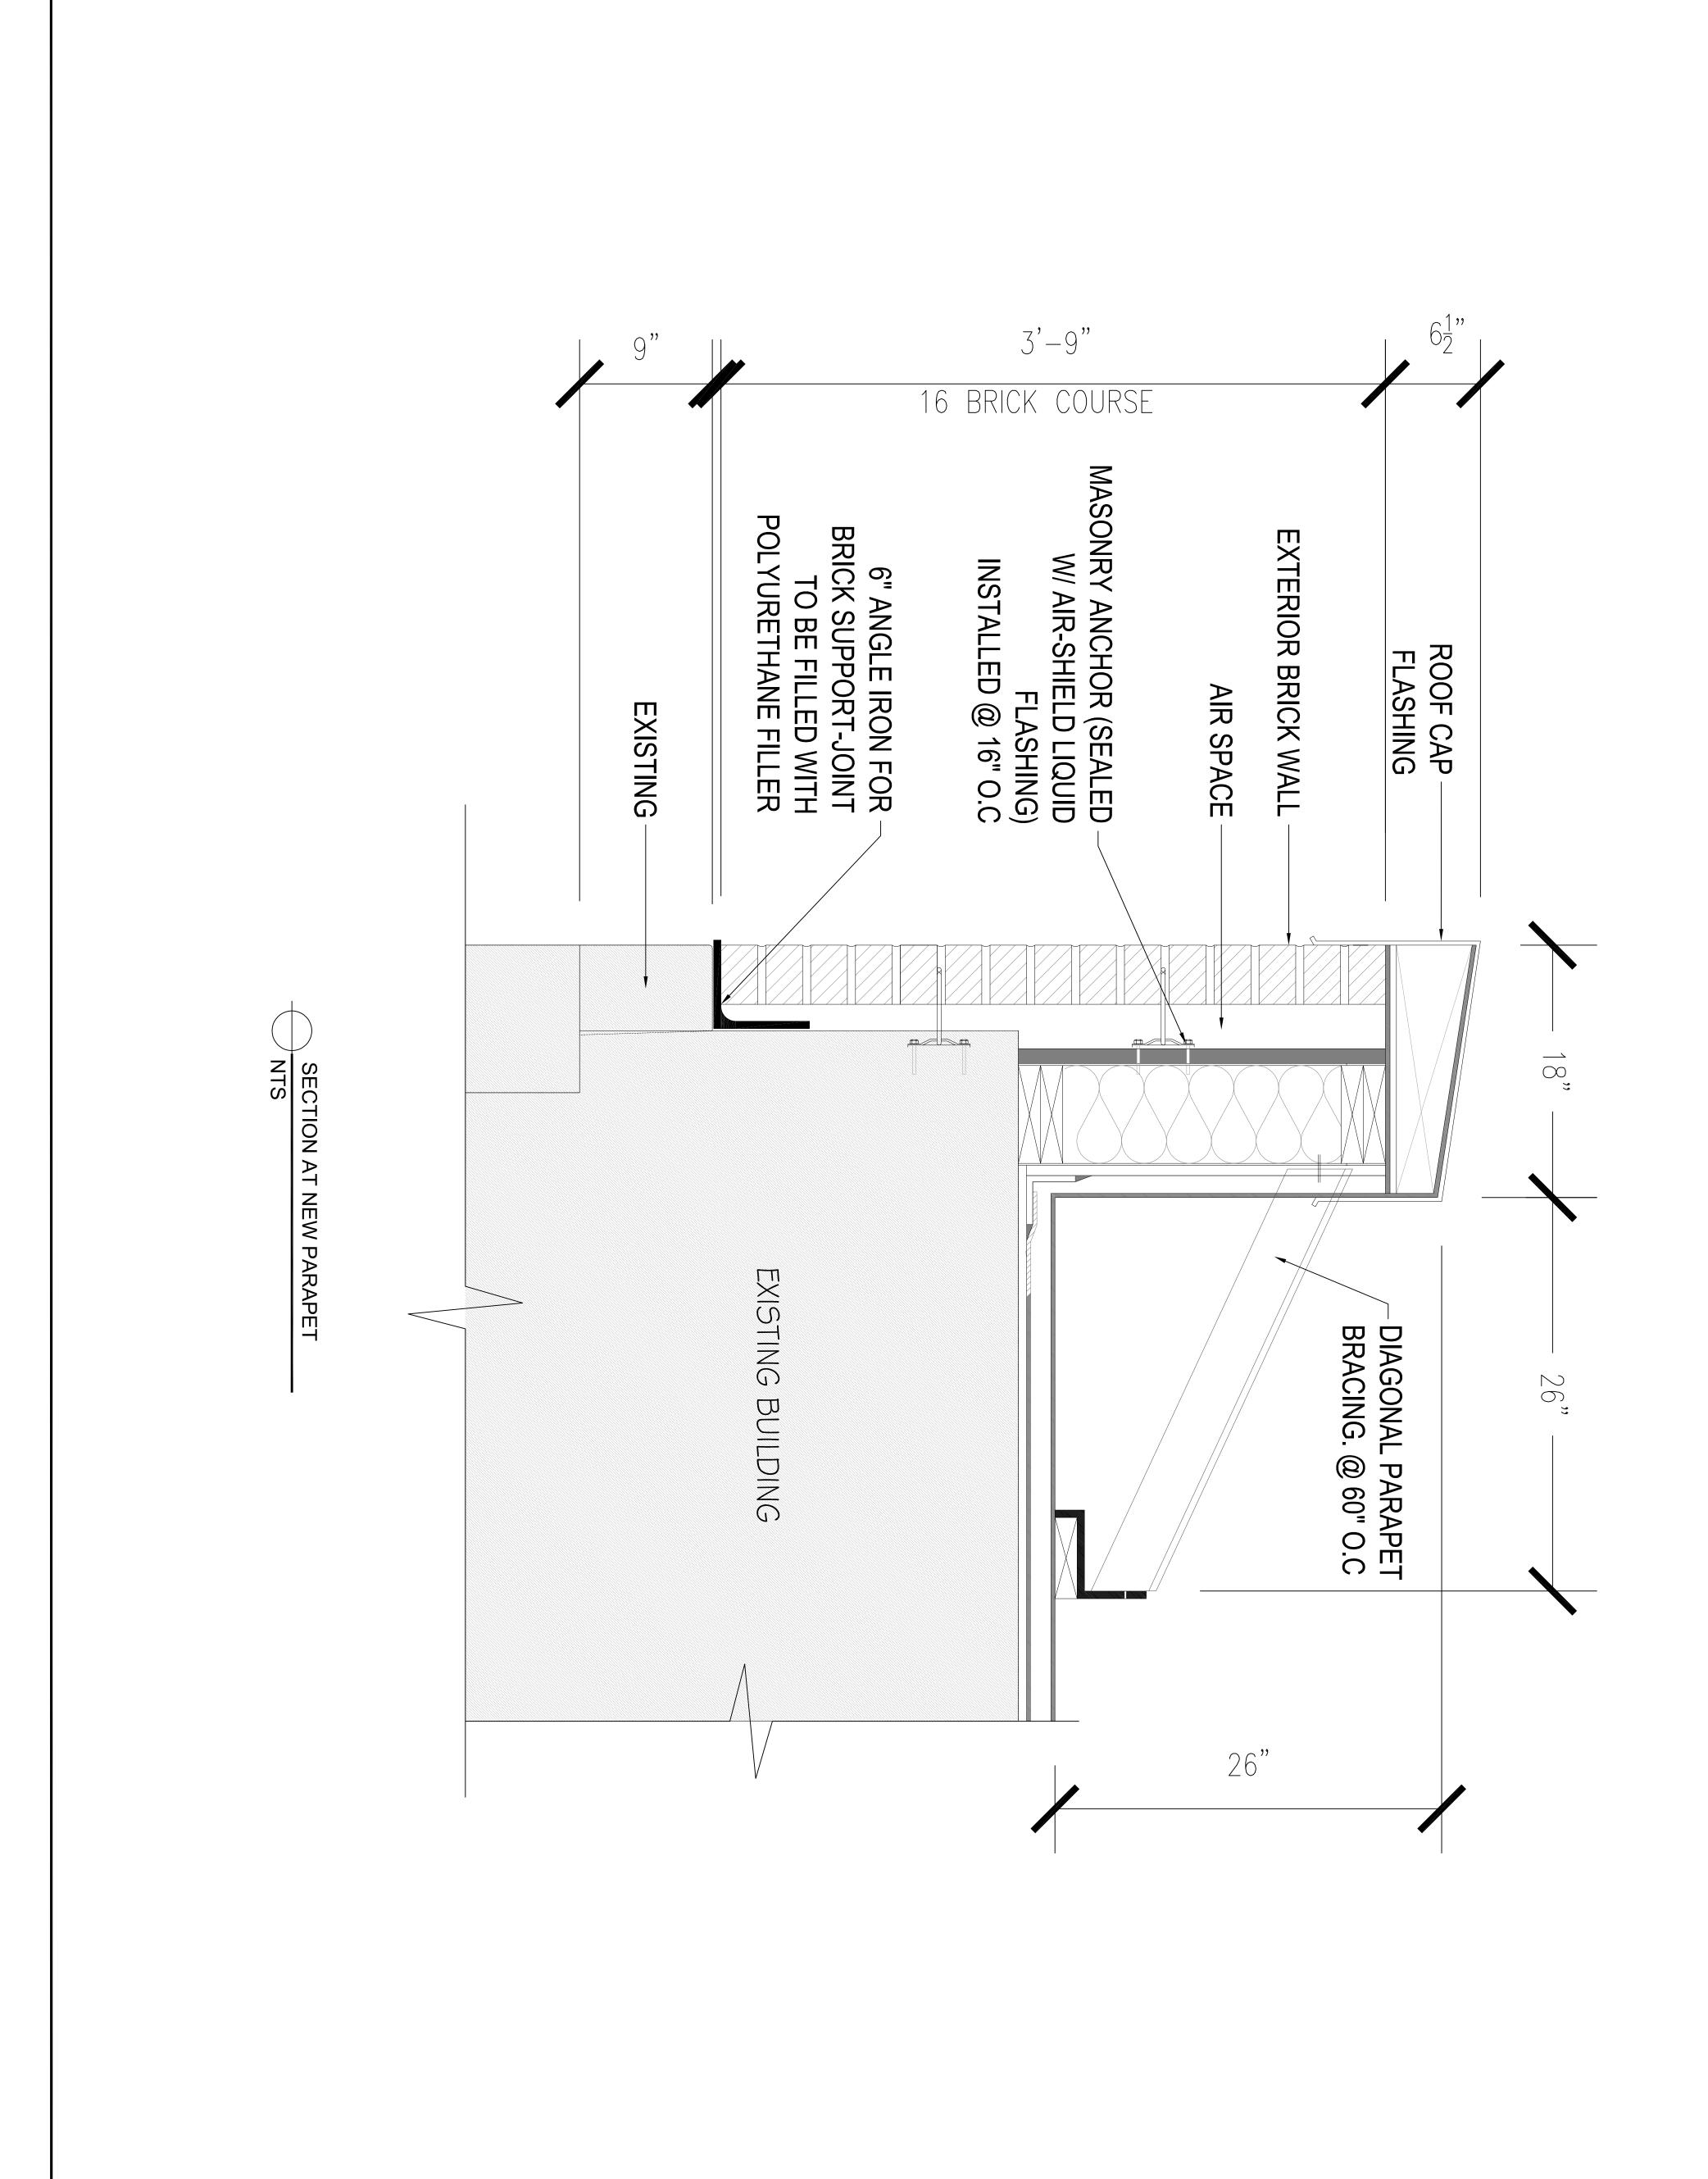

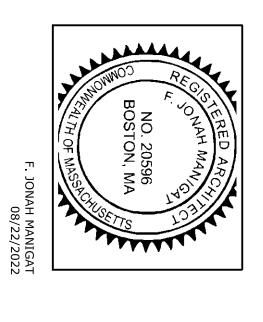


ADDRESS

583 Main Street

Reading, MA

MASONRY WORK
583 Main St. Reading MA

hIARCHi

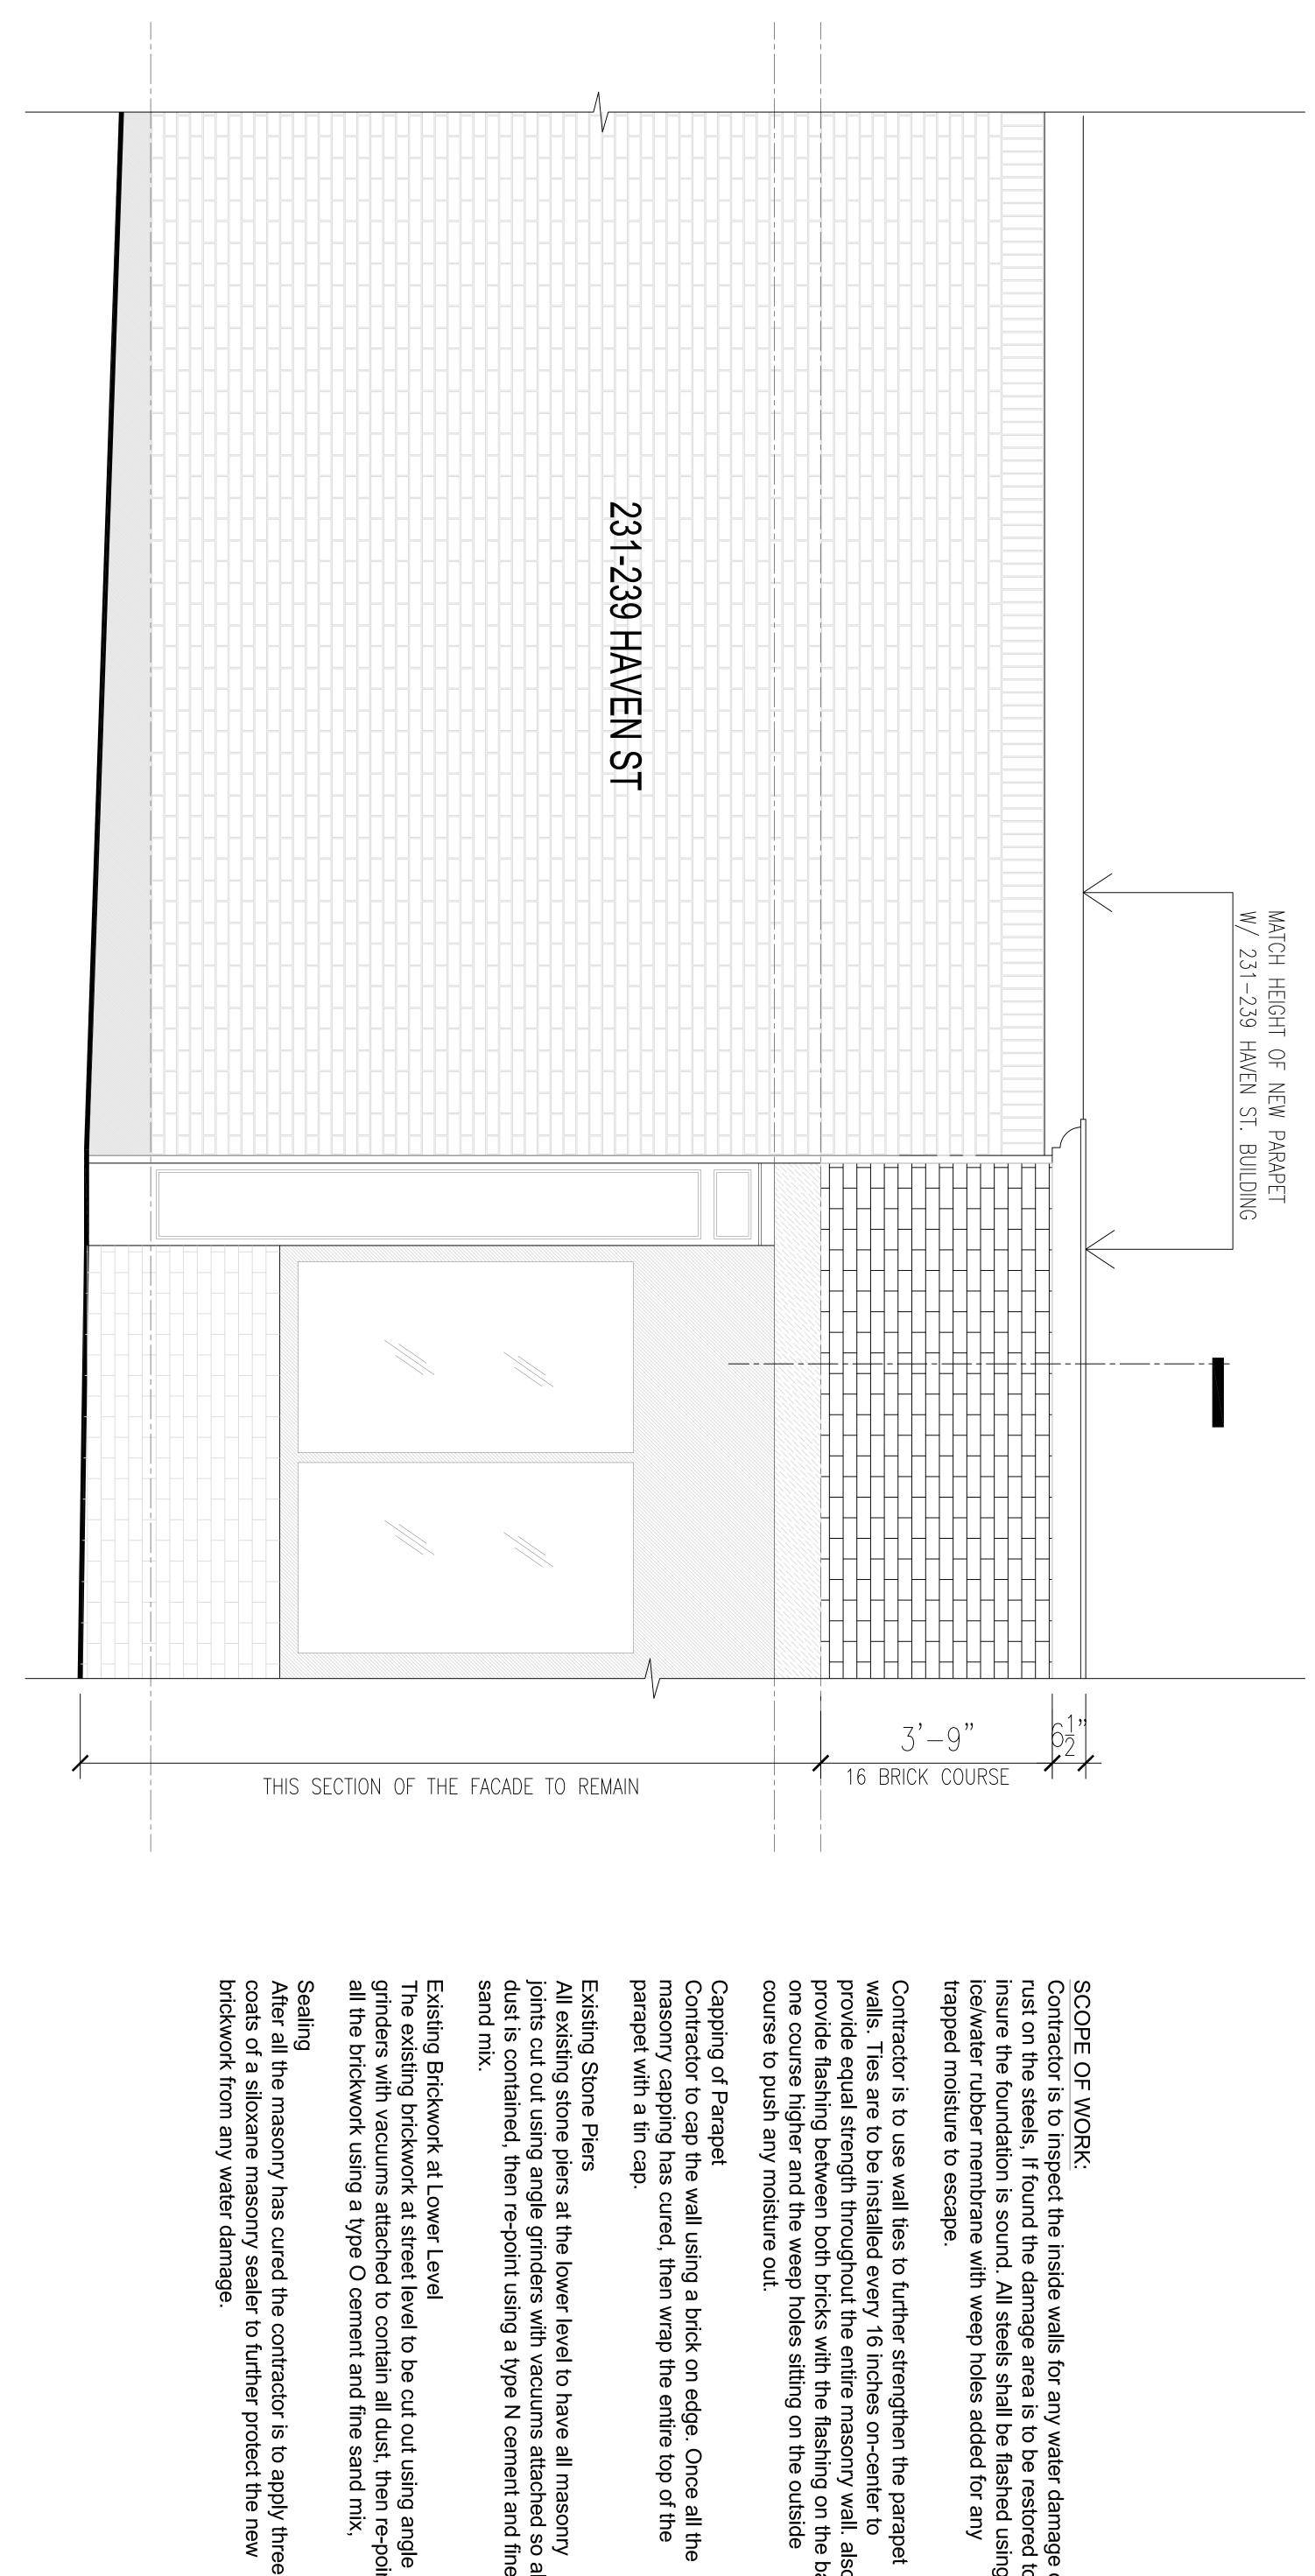

SCOPE OF WORK:

Contractor is to inspect the inside walls for any water damage or rust on the steels, If found the damage area is to be restored to insure the foundation is sound. All steels shall be flashed using an ice/water rubber membrane with weep holes added for any trapped moisture to escape.

Contractor is to use wall ties to further strengthen the parapet walls. Ties are to be installed every 16 inches on-center to provide equal strength throughout the entire masonry wall. also, provide flashing between both bricks with the flashing on the back one course higher and the weep holes sitting on the outside course to push any moisture out.

Capping of Parapet
Contractor to cap the wall using a brick on edge. Once all the masonry capping has cured, then wrap the entire top of the parapet with a tin cap.

Existing Stone Piers

All existing stone piers at the lower level to have all masonry joints cut out using angle grinders with vacuums attached so all dust is contained, then re-point using a type N cement and fine sand mix.

Existing Brickwork at Lower Level
The existing brickwork at street level to be cut out using angle
grinders with vacuums attached to contain all dust, then re-point
all the brickwork using a type O cement and fine sand mix,

PROPOSED ELEVA

TION

583 Main Street Reading, MA

MASONRY WORK 583 Main St. Reading MA

36 Bromfield Street Suite 208 Boston MA 02108

architecture + facilities design

COLLABORATIVE

hIARCHi


hIARCHi

F. JONAH MANIGAT 08/22/2022



583 Main Street Reading, MA

MASONRY WORK 583 Main St. Reading MA 36 Bromfield Street Suite 208 Boston MA 02108 h ARCHI COLLABORATIVE architecture + facilities design

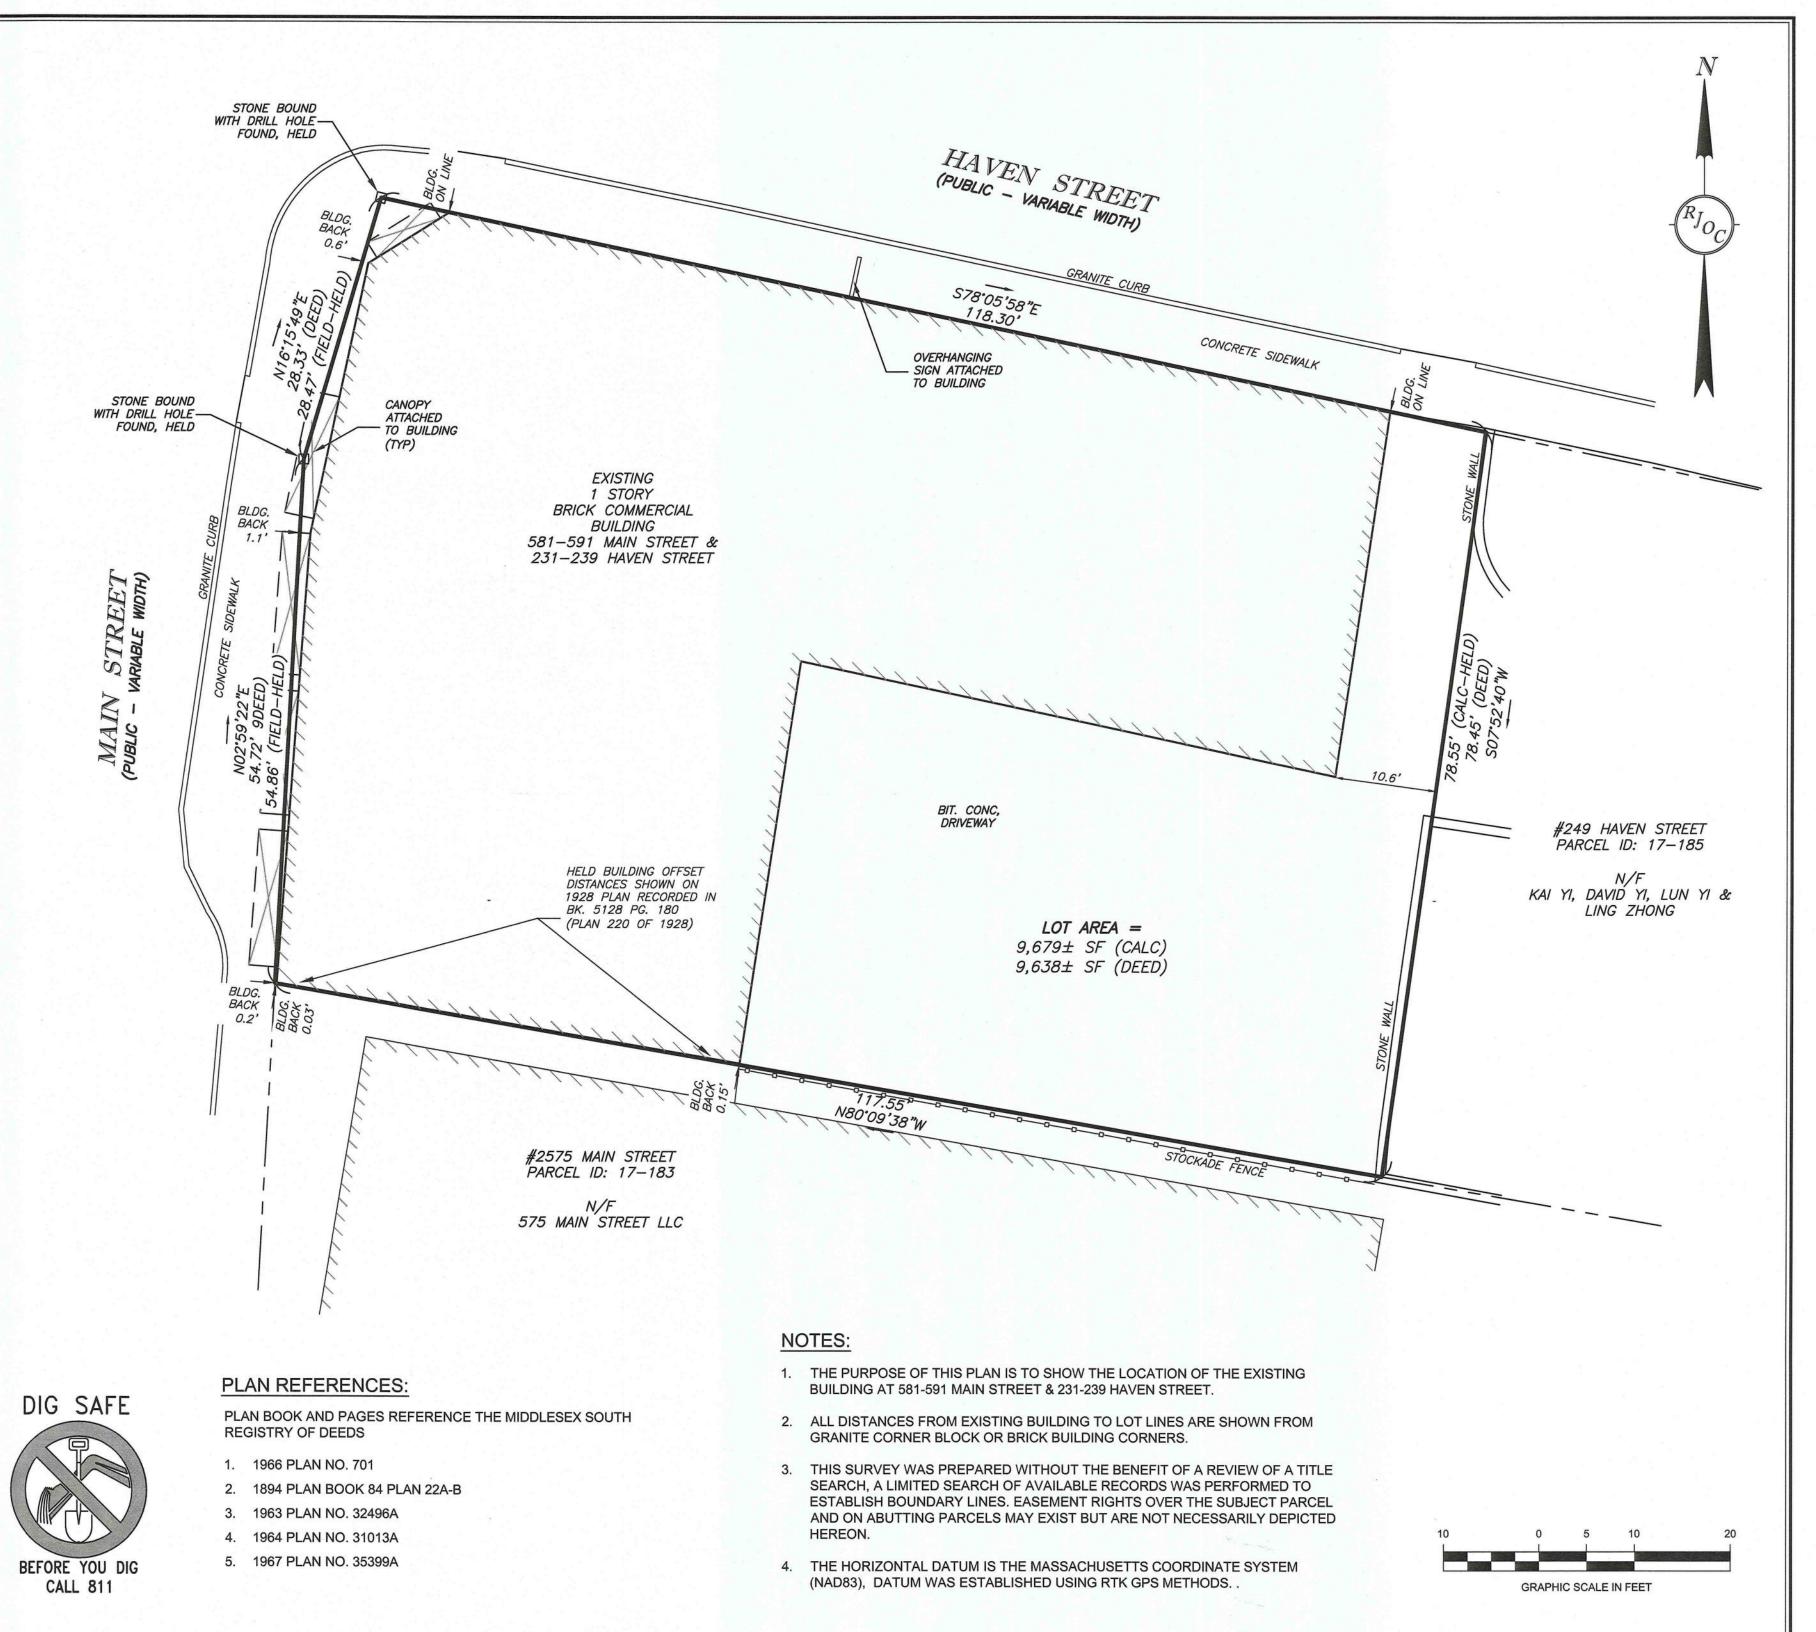



Record Owner:

THE TRIANTAFYLLIA LIAKOS **IRREVOCABLE TRUST 9R MILL STREET BURLINGTON, MA 01803** BK . 75190 PG. 227

Location: PARCEL ID: 017-018444 581-591 MAIN ST. & 231-239 HAVEN ST. READING, MA

PREPARED BY:

RJO'CONNELL & ASSOCIATES, INC.

CIVIL ENGINEERS, SURVEYORS & LAND PLANNERS 80 MONTVALE AVENUE, SUITE 201 STONEHAM, MA 02180 PHONE: 781.279.0180 RJOCONNELL.COM

PREPARED FOR:

JMS MASONRY AND RESTORATION, LLC

4 MANSION STREET STONEHAM, MA 02180

PROJECT NAME:

581-591 MAIN STREET & 231-239 HAVEN STREET

READING, MASSACHUSETTS

THIS PLAN IS THE RESULT OF AN ON THE GROUND SURVEY

MATTHEW LOWRY

PROFESSIONAL LAND SURVEYOR FOR

RJ O'CONNELL & ASSOCIATES, INC DRAWN BY: **REVIEWED BY** SCALE: 1" = 10' TDB / EC FIELD CREW: FIELD BOOK: FIELD BOOK 47 / PG. 52

REVISED:

DRAWING NAME:

PLOT PLAN

DRAWING NUMBER:


PP-1

PROJECT NUMBER:

22539

6/10/2022

Copyright © 2022 by R.J. O'Connell & Associates, Inc.

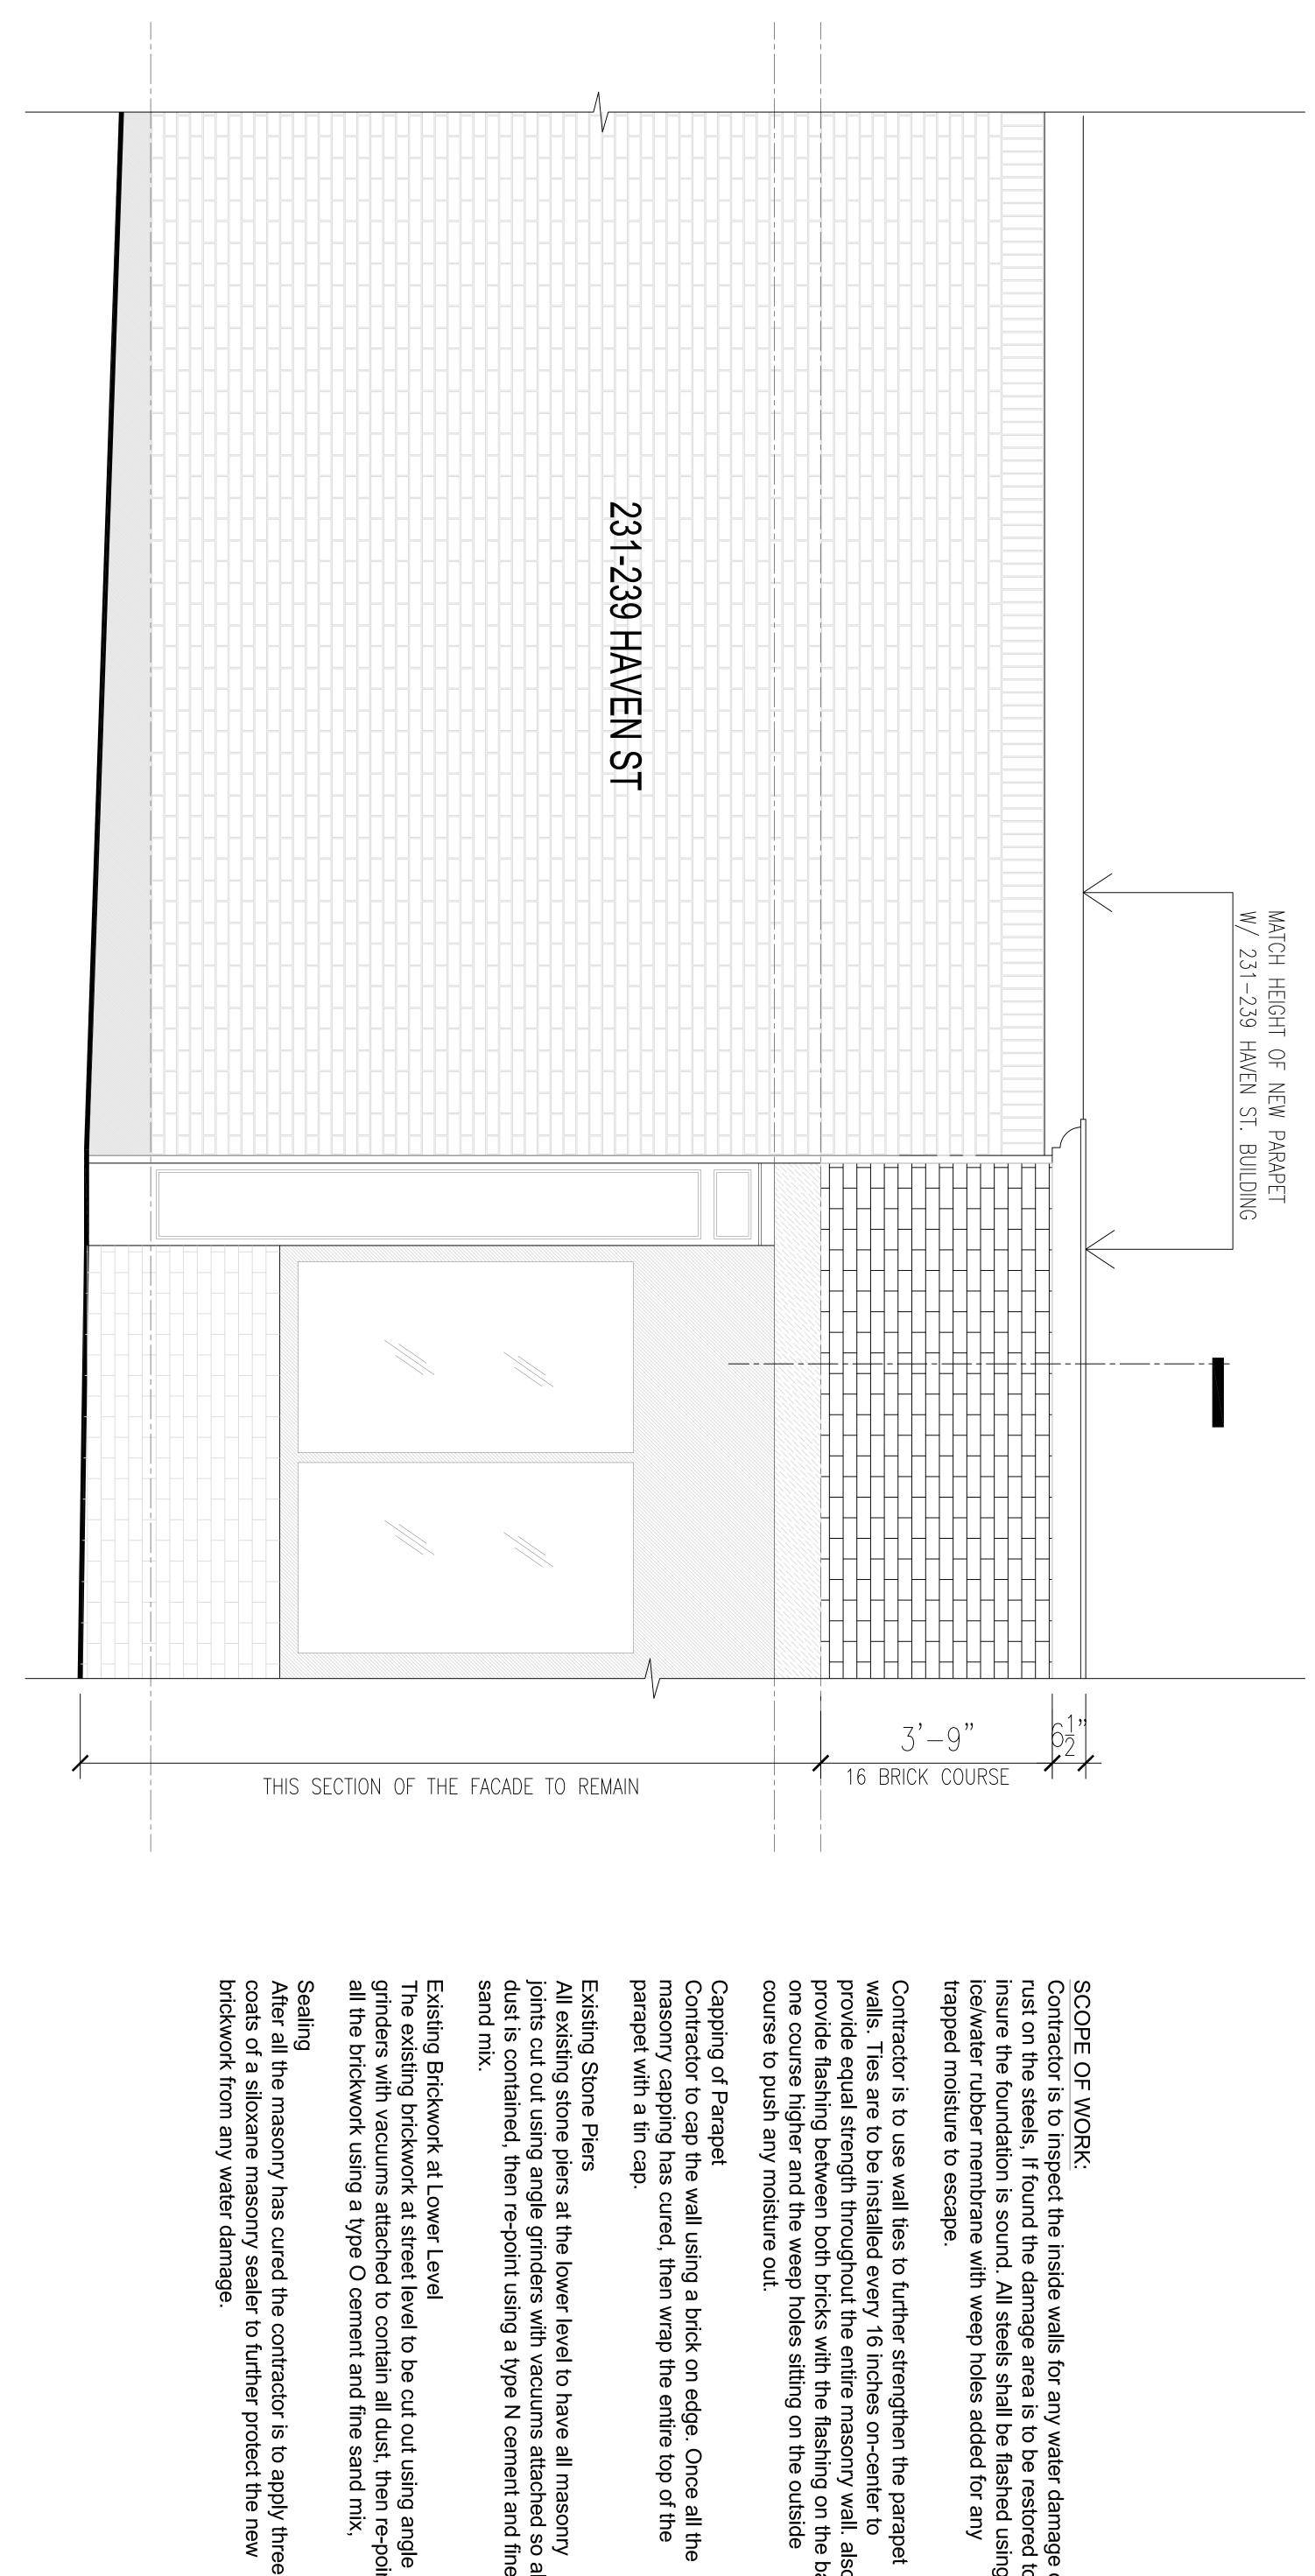

SCOPE OF WORK:

Contractor is to inspect the inside walls for any water damage or rust on the steels, If found the damage area is to be restored to insure the foundation is sound. All steels shall be flashed using an ice/water rubber membrane with weep holes added for any trapped moisture to escape.

Contractor is to use wall ties to further strengthen the parapet walls. Ties are to be installed every 16 inches on-center to provide equal strength throughout the entire masonry wall. also, provide flashing between both bricks with the flashing on the back one course higher and the weep holes sitting on the outside course to push any moisture out.

Capping of Parapet
Contractor to cap the wall using a brick on edge. Once all the masonry capping has cured, then wrap the entire top of the parapet with a tin cap.

Existing Stone Piers

All existing stone piers at the lower level to have all masonry joints cut out using angle grinders with vacuums attached so all dust is contained, then re-point using a type N cement and fine sand mix.

Existing Brickwork at Lower Level
The existing brickwork at street level to be cut out using angle
grinders with vacuums attached to contain all dust, then re-point
all the brickwork using a type O cement and fine sand mix,

PROPOSED ELEVA

TION

583 Main Street Reading, MA

MASONRY WORK 583 Main St. Reading MA

36 Bromfield Street Suite 208 Boston MA 02108


architecture + facilities design

COLLABORATIVE

hIARCHi

hIARCHi

F. JONAH MANIGAT 08/22/2022

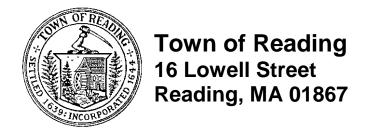

Andrew MacNichol Senior Planner Phone: 781.942-6670 Fax: 781.942-9071

Website: www.readingma.gov

November 7, 2022

CPDC SIGN REVIEW

Certificate of Appropriateness

Project/Applicant: 77 Haven Street – Rocco's Hair Salon

On November 7, 2022, the Community Planning and Development Commission (CPDC) took the following action with respect to an application dated October 25, 2022 by FASTSIGNS of Woburn, on behalf of Rocco's Hair Salon, for a business located at 77 Haven Street:

"We, the Reading Community Planning and Development Commission, do hereby vote XXX to approve the application for a Certificate of Appropriateness as reviewed on November 7, 2022, for the installation of signage related to a business at 77 Haven Street, subject to the Findings and Conditions below."

Materials Submitted:

The following materials were submitted into the public record:

- a) Application for Sign Permit, dated 10/25/22;
- b) Colored rendering of the proposed signage as it relates to the building elevations, prepared by FASTSIGNS of Woburn, received 10/25/22;
- c) Draft Certificate of Appropriateness, dated 11/7/22.

Findings:

- 1. The site is located within the Business-B Zoning District. Signs within the Business-B Zoning District are subject to approval by the Community Planning and Development Commission.
- 2. The Applicant is seeking to replace and install a new wall sign on the building's western façade fronting Haven Street.
- 3. The proposed wall sign shall:
 - Measure 5'10" long X 1'4.5" wide for a total area of 8 square feet;
 - Consist of 2" thick satin finished stainless-steel lettering with ½" matter acrylic material colored black. The lettering is spaced 1.5" off of the building facade, for a projecting total of 4";
 - Be illuminated through Halo-Lit white LED fixtures. Opaque aluminum facing and siding shall shield the light source from visibility on Haven Street. The LED lighting shall project backwards onto the façade of the building; and,
 - Be stud mounted on the building's western façade fronting Haven Street;

Conditions:

- 1. Prior to the issuance of a Building Permit the Applicant shall submit a revised Sign Permit Application depicting the correct width and square footage of the wall sign;
- 2. If any tenant window signage is applied in the future, it must comply with Zoning Bylaw Section 8.5.1(d).
- 3. The sign shall be designed and installed in the style, materials and colors depicted on the documents submitted and approved herein by the Commission. Should the design need to deviate substantially from what is approved, the applicant may need to return to CPDC.
- 4. The Applicant shall obtain any necessary Building Permits and Electrical Permits prior to the installation of the proposed signage.

Signed	as to	the acc	uracy o	f the	vote a	is ref	lected	in	the	minutes:
--------	-------	---------	---------	-------	--------	--------	--------	----	-----	----------

Andrew MacNichol, Senior Planner Date

Cc: Applicant, Town Clerk, Building Inspector, planning file

25 HAVEN ST. ©

O'SULLIVAN ARCHITECTURE ■INTERIORS ■ PLANNIN

READING, MA

SUBMISSION DRAWING LIST REVISED: 10/24/2022

A0.01	PROJECT DATA SHEET
A1.01	GROUND FLOOR PLAN
A1.02	SECOND FLOOR PLAN
A1.03	THIRD FLOOR PLAN
A1.04	FOURTH FLOOR PLAN
A1.05	ROOF PLAN
A3.01	ELEVATIONS
A3.02	ELEVATIONS
A3.10	PERSPECTIVES
A3.11	PERSPECTIVES
A3.12	PERSPECTIVES
A4.01	SECTIONS






ARCHITECT O'SULLIVAN ARCHITECTS 606 MAIN STREET, SUITE 3001 READING, MA 01867-3009 Voice: (781) 439-6166

Fax: (781) 439-6170


DEVELOPER 25 HAVEN STREET LLC 611 SALEM STREET WAKEFIELD, MA 01880 Voice: (781) 572-3033

PERMITTING ATTORNEY LATHAM LAW OFFICES LLC 643 MAIN STREET READING, MA 01867-3009 Voice: (781) 942-4400 Fax: (781) 989-3239


CIVIL ENGINEER HAYES ENGINEERING 303 SALEM STREET WAKEFIELD, MA 01880 Voice: (781) 246-2800 Fax: (781) 246-7596

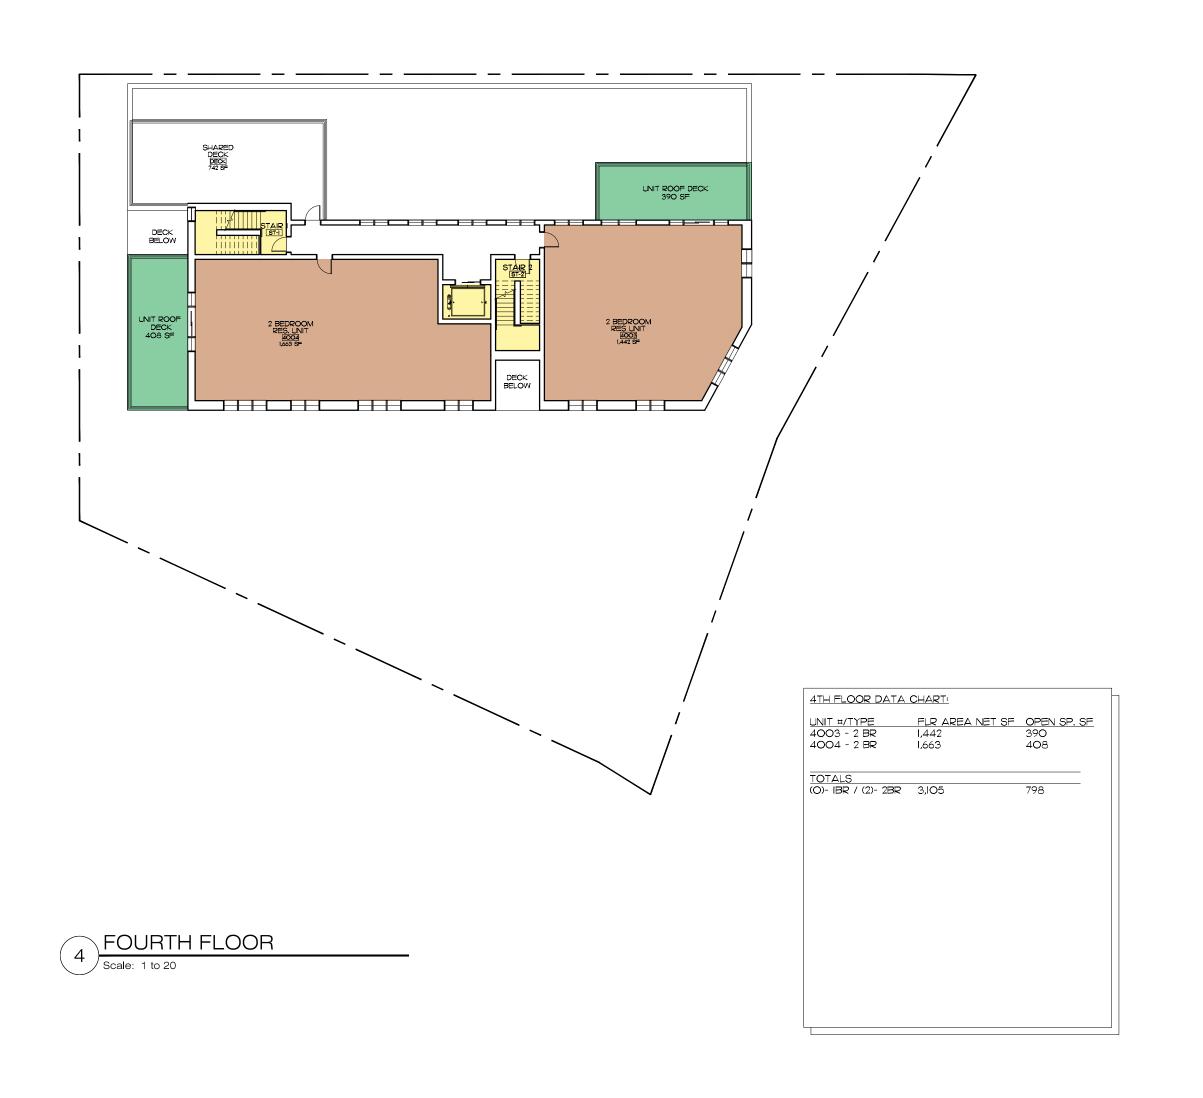



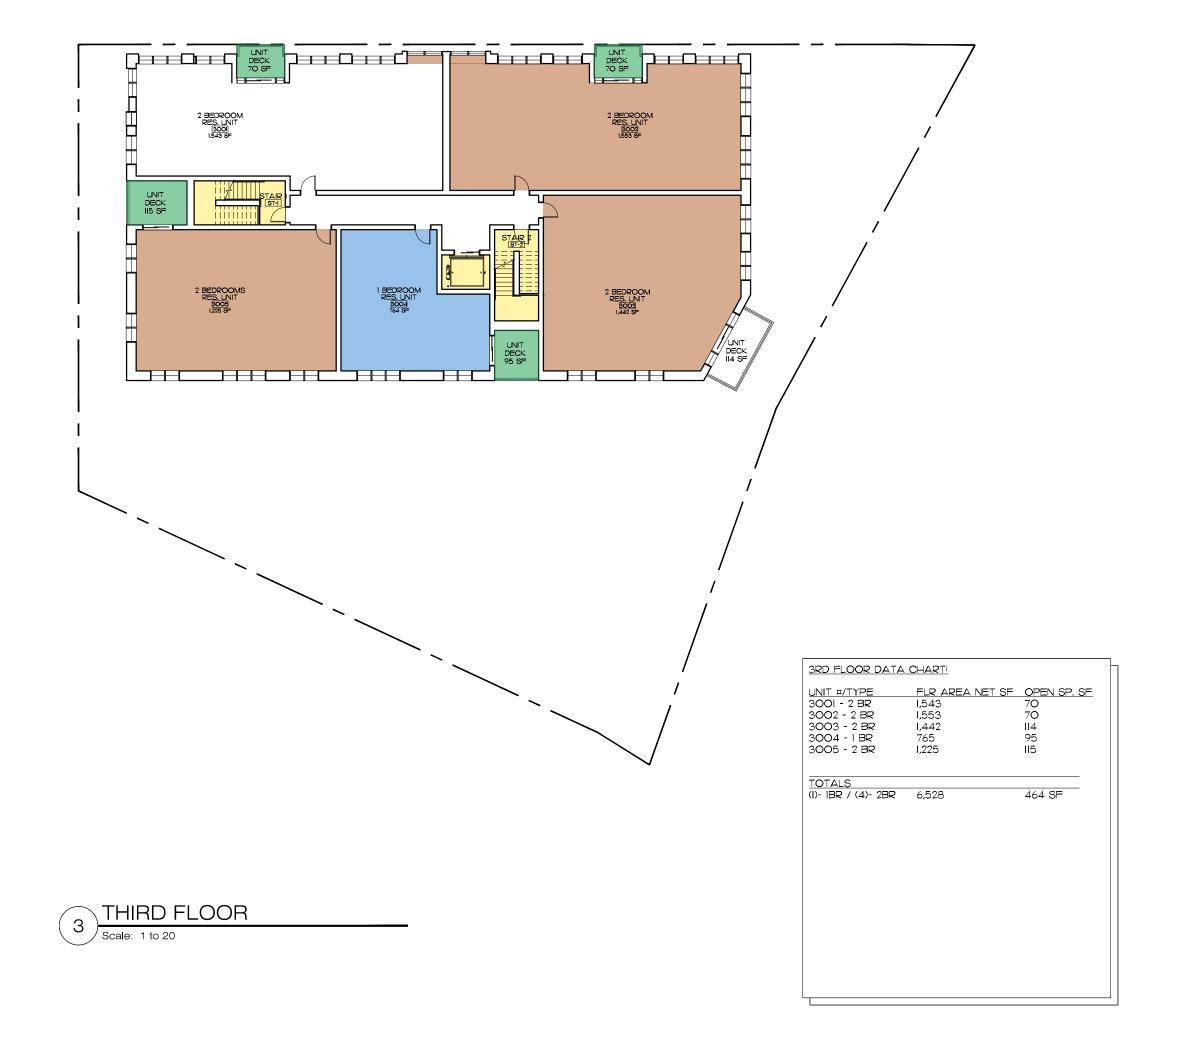



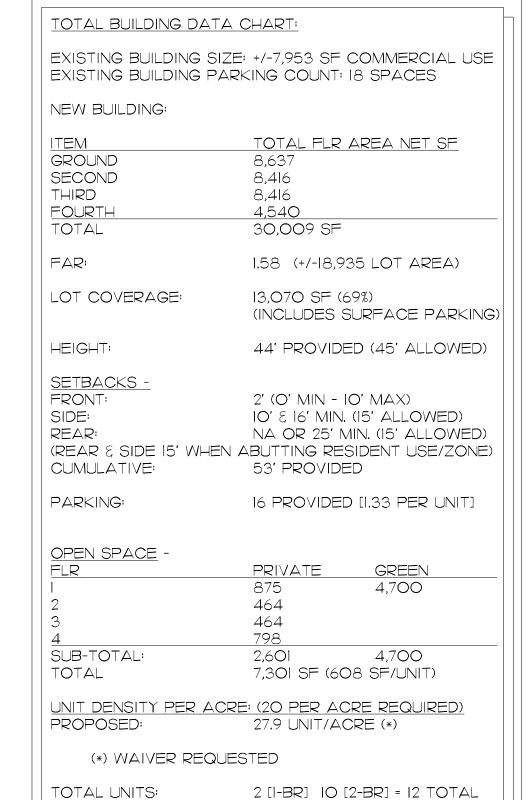

RELIEF REQUEST CHART

MAX F.A.R.

MIN. LOT FRONTAGE MAX LOT COVERGE MIN. LOT AREA	50' NA NA	186'-9" 69% +/-18,935	N N N	
MAX, BLDG FRONTAGE YARD SETBACKS:	300'	158'-6"	N	
FRONT (MIN/MAX)	0'/10'	2'/	N	
MIN. SIDE MIN. REAR	O' (OR 15') O' (OR 15')	10' /16' MIN. 25' MIN	N N	
INTERIOR BETWEEN	O (OK 10)	20 IVIII N	1 N	
BLDGS MIN.	15'	NA	N	
DWELLING UNIT PER ACRE:	20	27.9	Y	
MIN. PARKING:	1.25 (15)	1.33 (16)	N	25 Haven Street
				Reading, MA

REQUIRED. PROVIDED RELIEF (Y/N)

2.8 (MIXED USE) 1.58

2 BR UNIT TYPE

I BR UNIT TYPE

EGRESS/CIRCULATION

COMMERCIAL SPACE

UTILITY/MECHANICAL SPACE

PRIVATE OPEN SPACE FOR BUILDING TENANT USE

SEMI-PUBLIC OPEN SPACE

RESIDENT LOBBY

OPEN SPACE TYPES:

OPEN SPACE

Project Data Page

O'SULLIVAN

ARCHITECTS, INC.

ARCHITECTURE ■ INTERIORS ■ PLANNING

606 MAIN STREET, SUITE 3001

READING, MASSACHUSETTS 01867

Tel: (781) 439-6166 Fax: (781) 439-6170


www.osullivanarchitects.com

These drawings and specifications were prepared

for use at the location indicated. Publication and use is expressly limited to the identified location. Reuse or reproduction by any method, in whole

or in part, is prohibited without the written permission of O'Sullivan Architects, Inc.

© 2021 O'Sullivan Architects Inc.

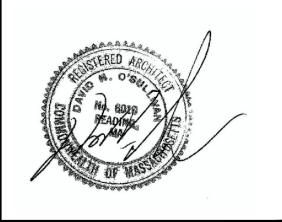


SCALE: As Noted

ISSUED / DRAWN BY 4/29/2022

REVISED / REVISED BY 10/24/2022 - REV SUBMISSIONS

JOB NO: 21015

SHEET NUMBER

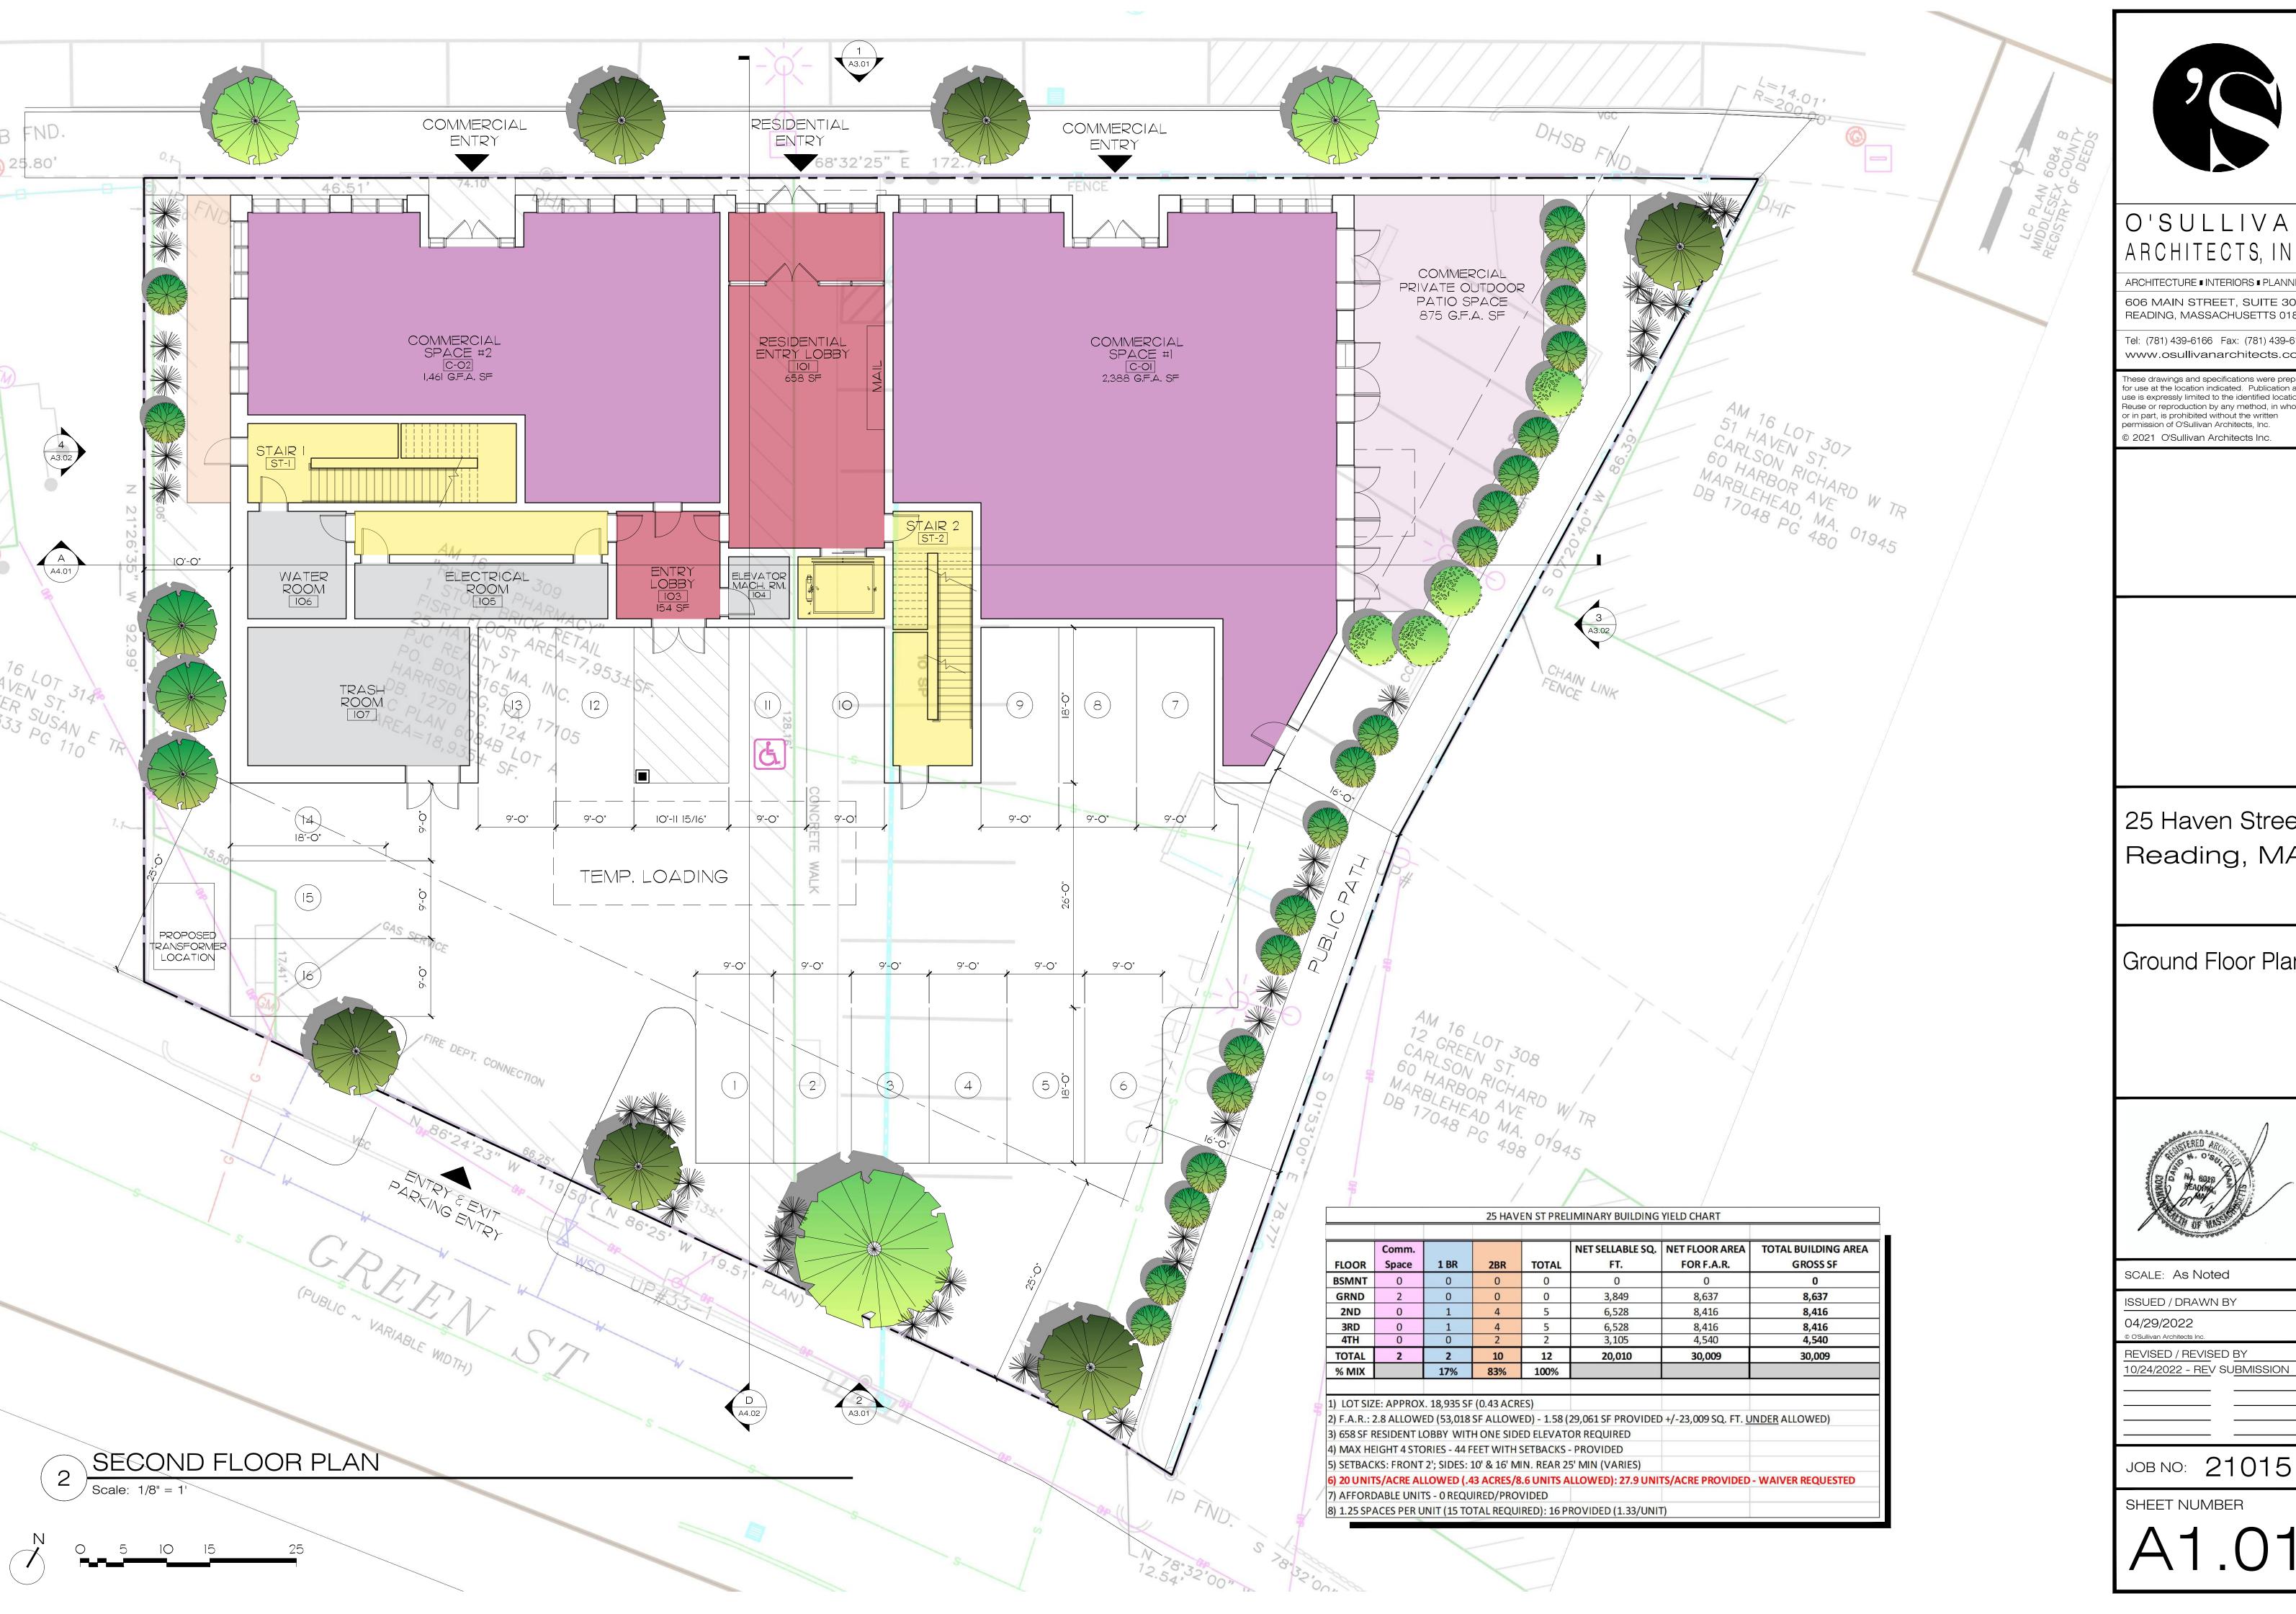



ARCHITECTURE ■ INTERIORS ■ PLANNING 606 MAIN STREET, SUITE 3001 READING, MASSACHUSETTS 01867

Tel: (781) 439-6166 Fax: (781) 439-6170 www.osullivanarchitects.com

These drawings and specifications were prepared for use at the location indicated. Publication and use is expressly limited to the identified location. Reuse or reproduction by any method, in whole or in part, is prohibited without the written permission of O'Sullivan Architects, Inc. © 2021 O'Sullivan Architects Inc.

25 Haven Street Reading, MA


Ground Floor Plan




REVISED / REVISED BY

JOB NO: 21015

SHEET NUMBER

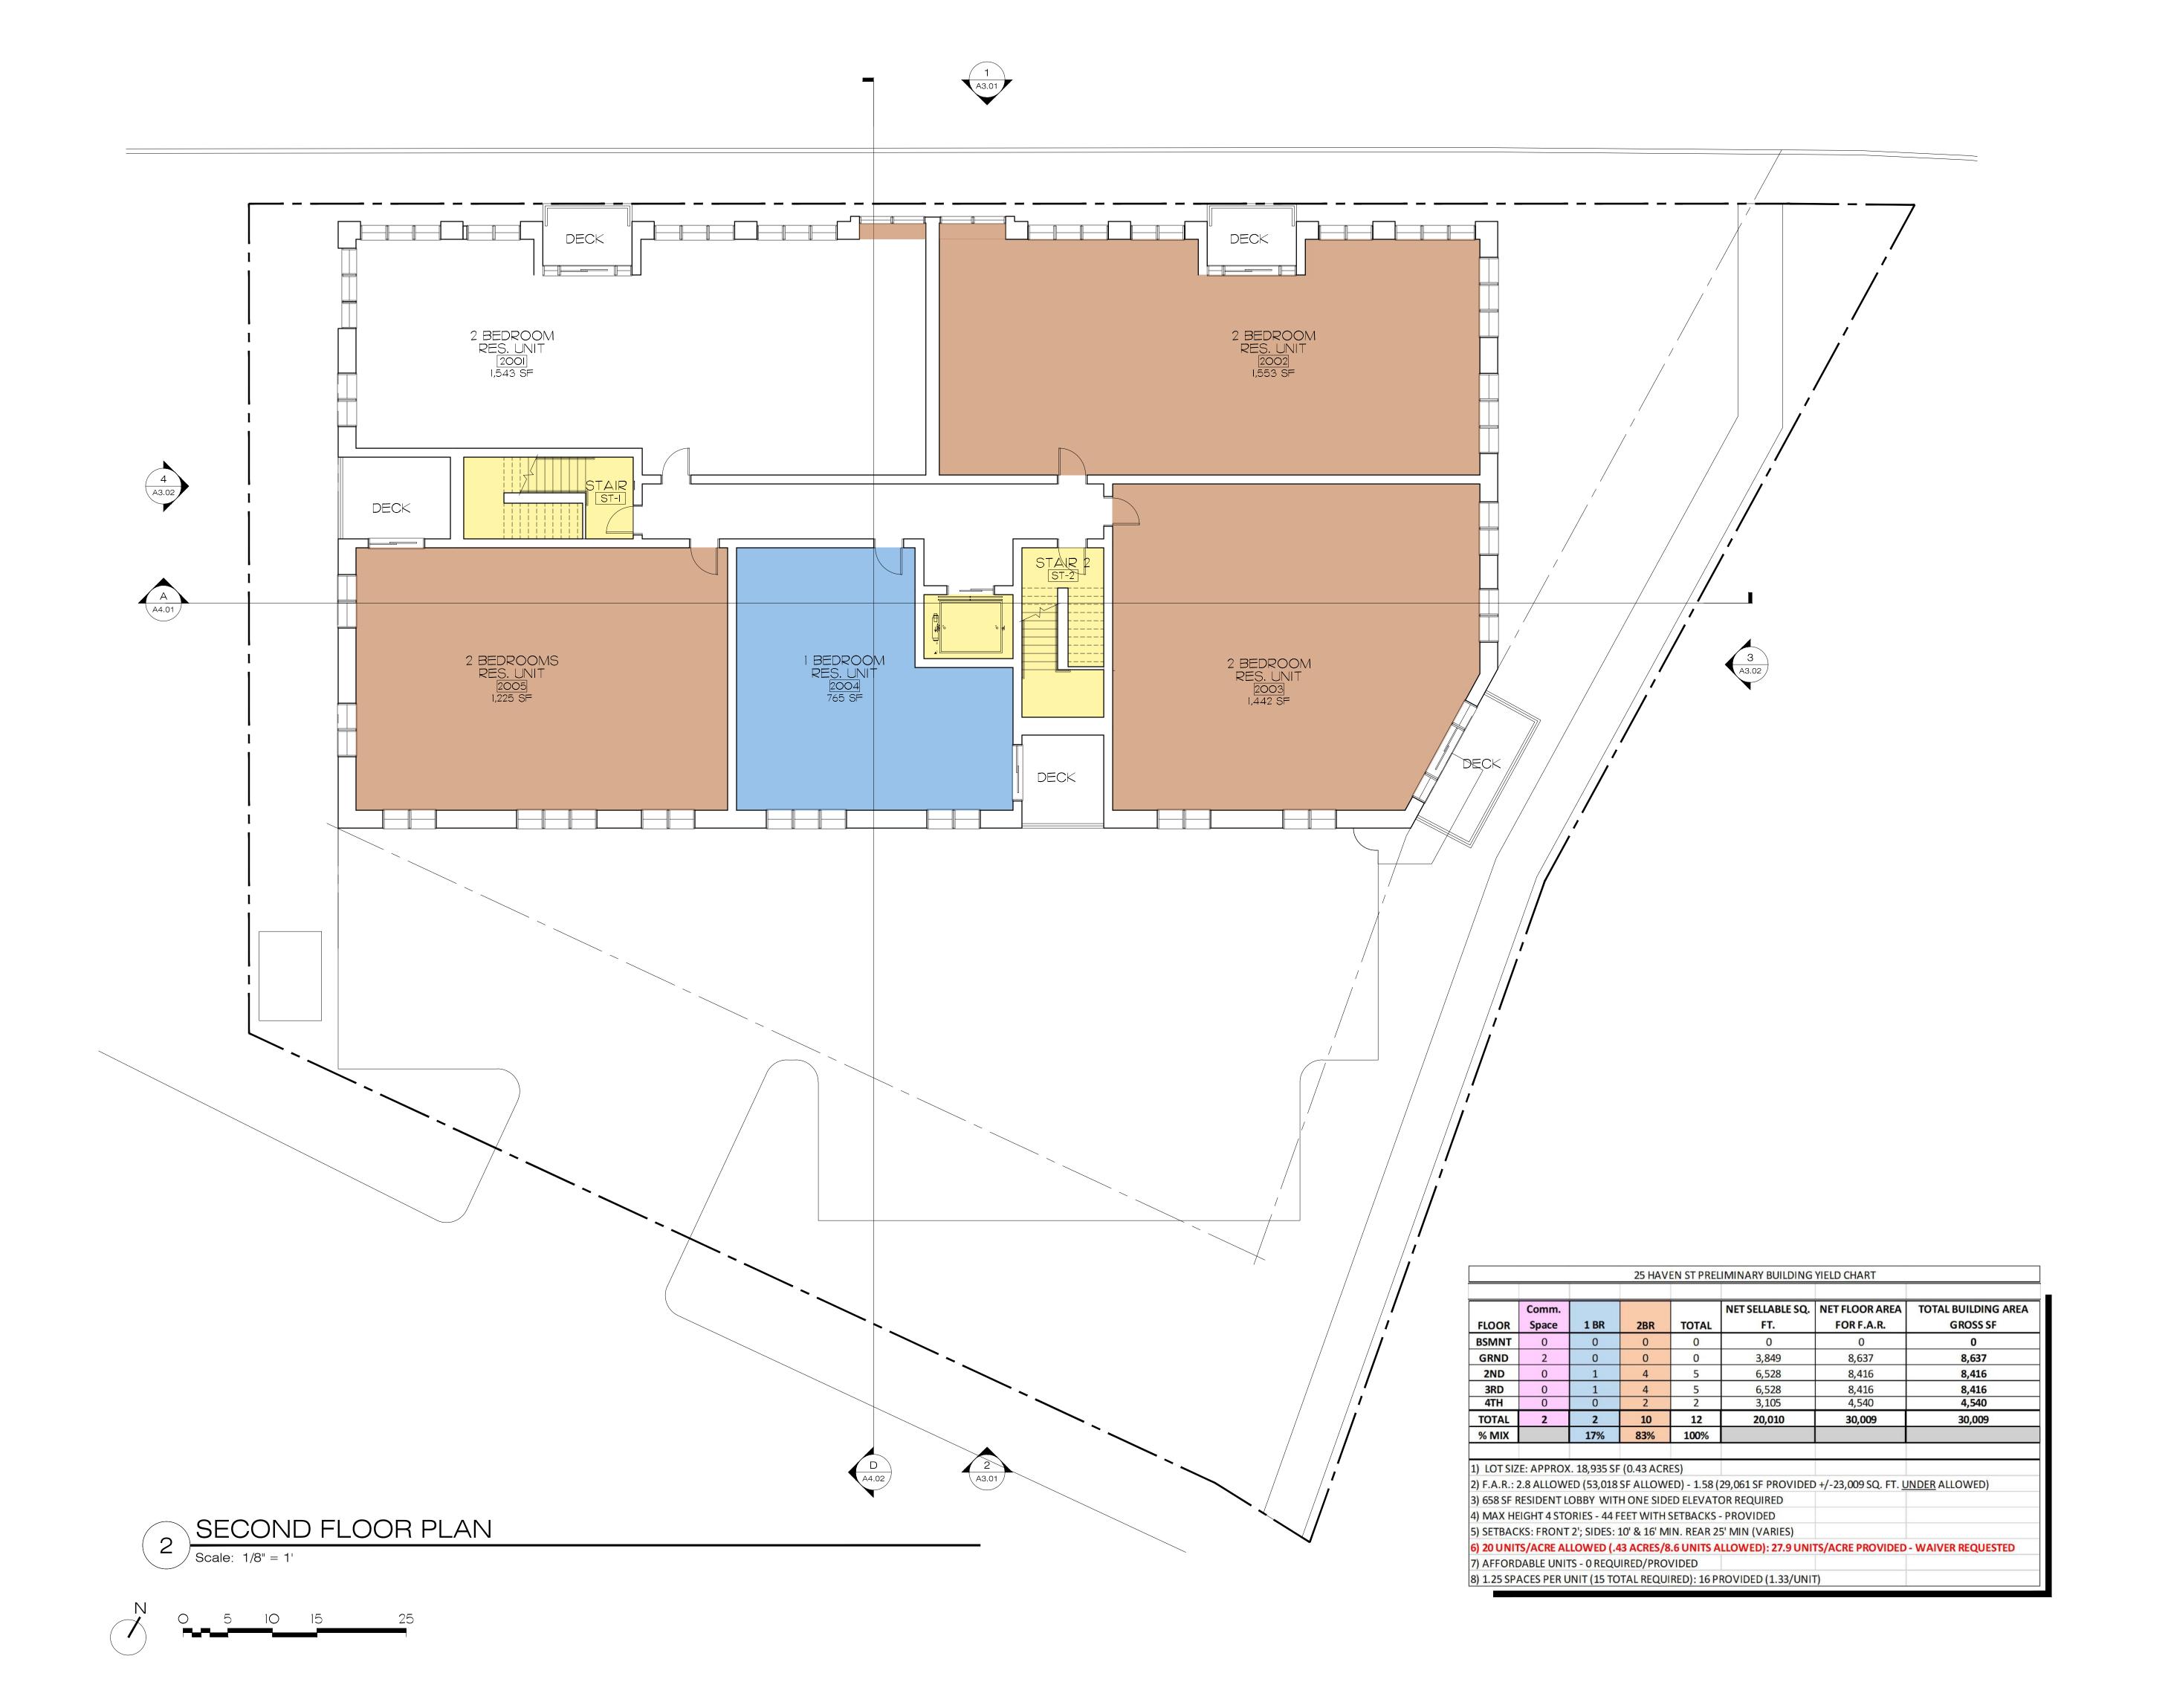

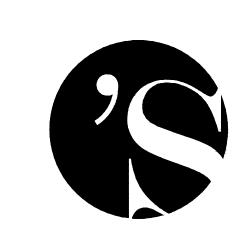

ARCHITECTURE INTERIORS PLANNING
606 MAIN STREET, SUITE 3001
READING, MASSACHUSETTS 01867


Tel: (781) 439-6166 Fax: (781) 439-6170 www.osullivanarchitects.com

These drawings and specifications were prepared for use at the location indicated. Publication and use is expressly limited to the identified location. Reuse or reproduction by any method, in whole or in part, is prohibited without the written permission of O'Sullivan Architects, Inc.

© 2021 O'Sullivan Architects Inc.

25 Haven Street Reading, MA

Second Floor Plan

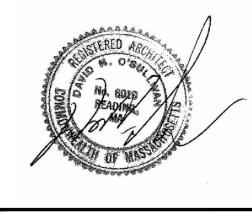

SCALE: As Noted

ISSUED / DRAWN BY

4/29/2022


REVISED / REVISED BY


10/24/2022 - REV SUBMISSION

JOB NO: 21015

SHEET NUMBER

A1.02

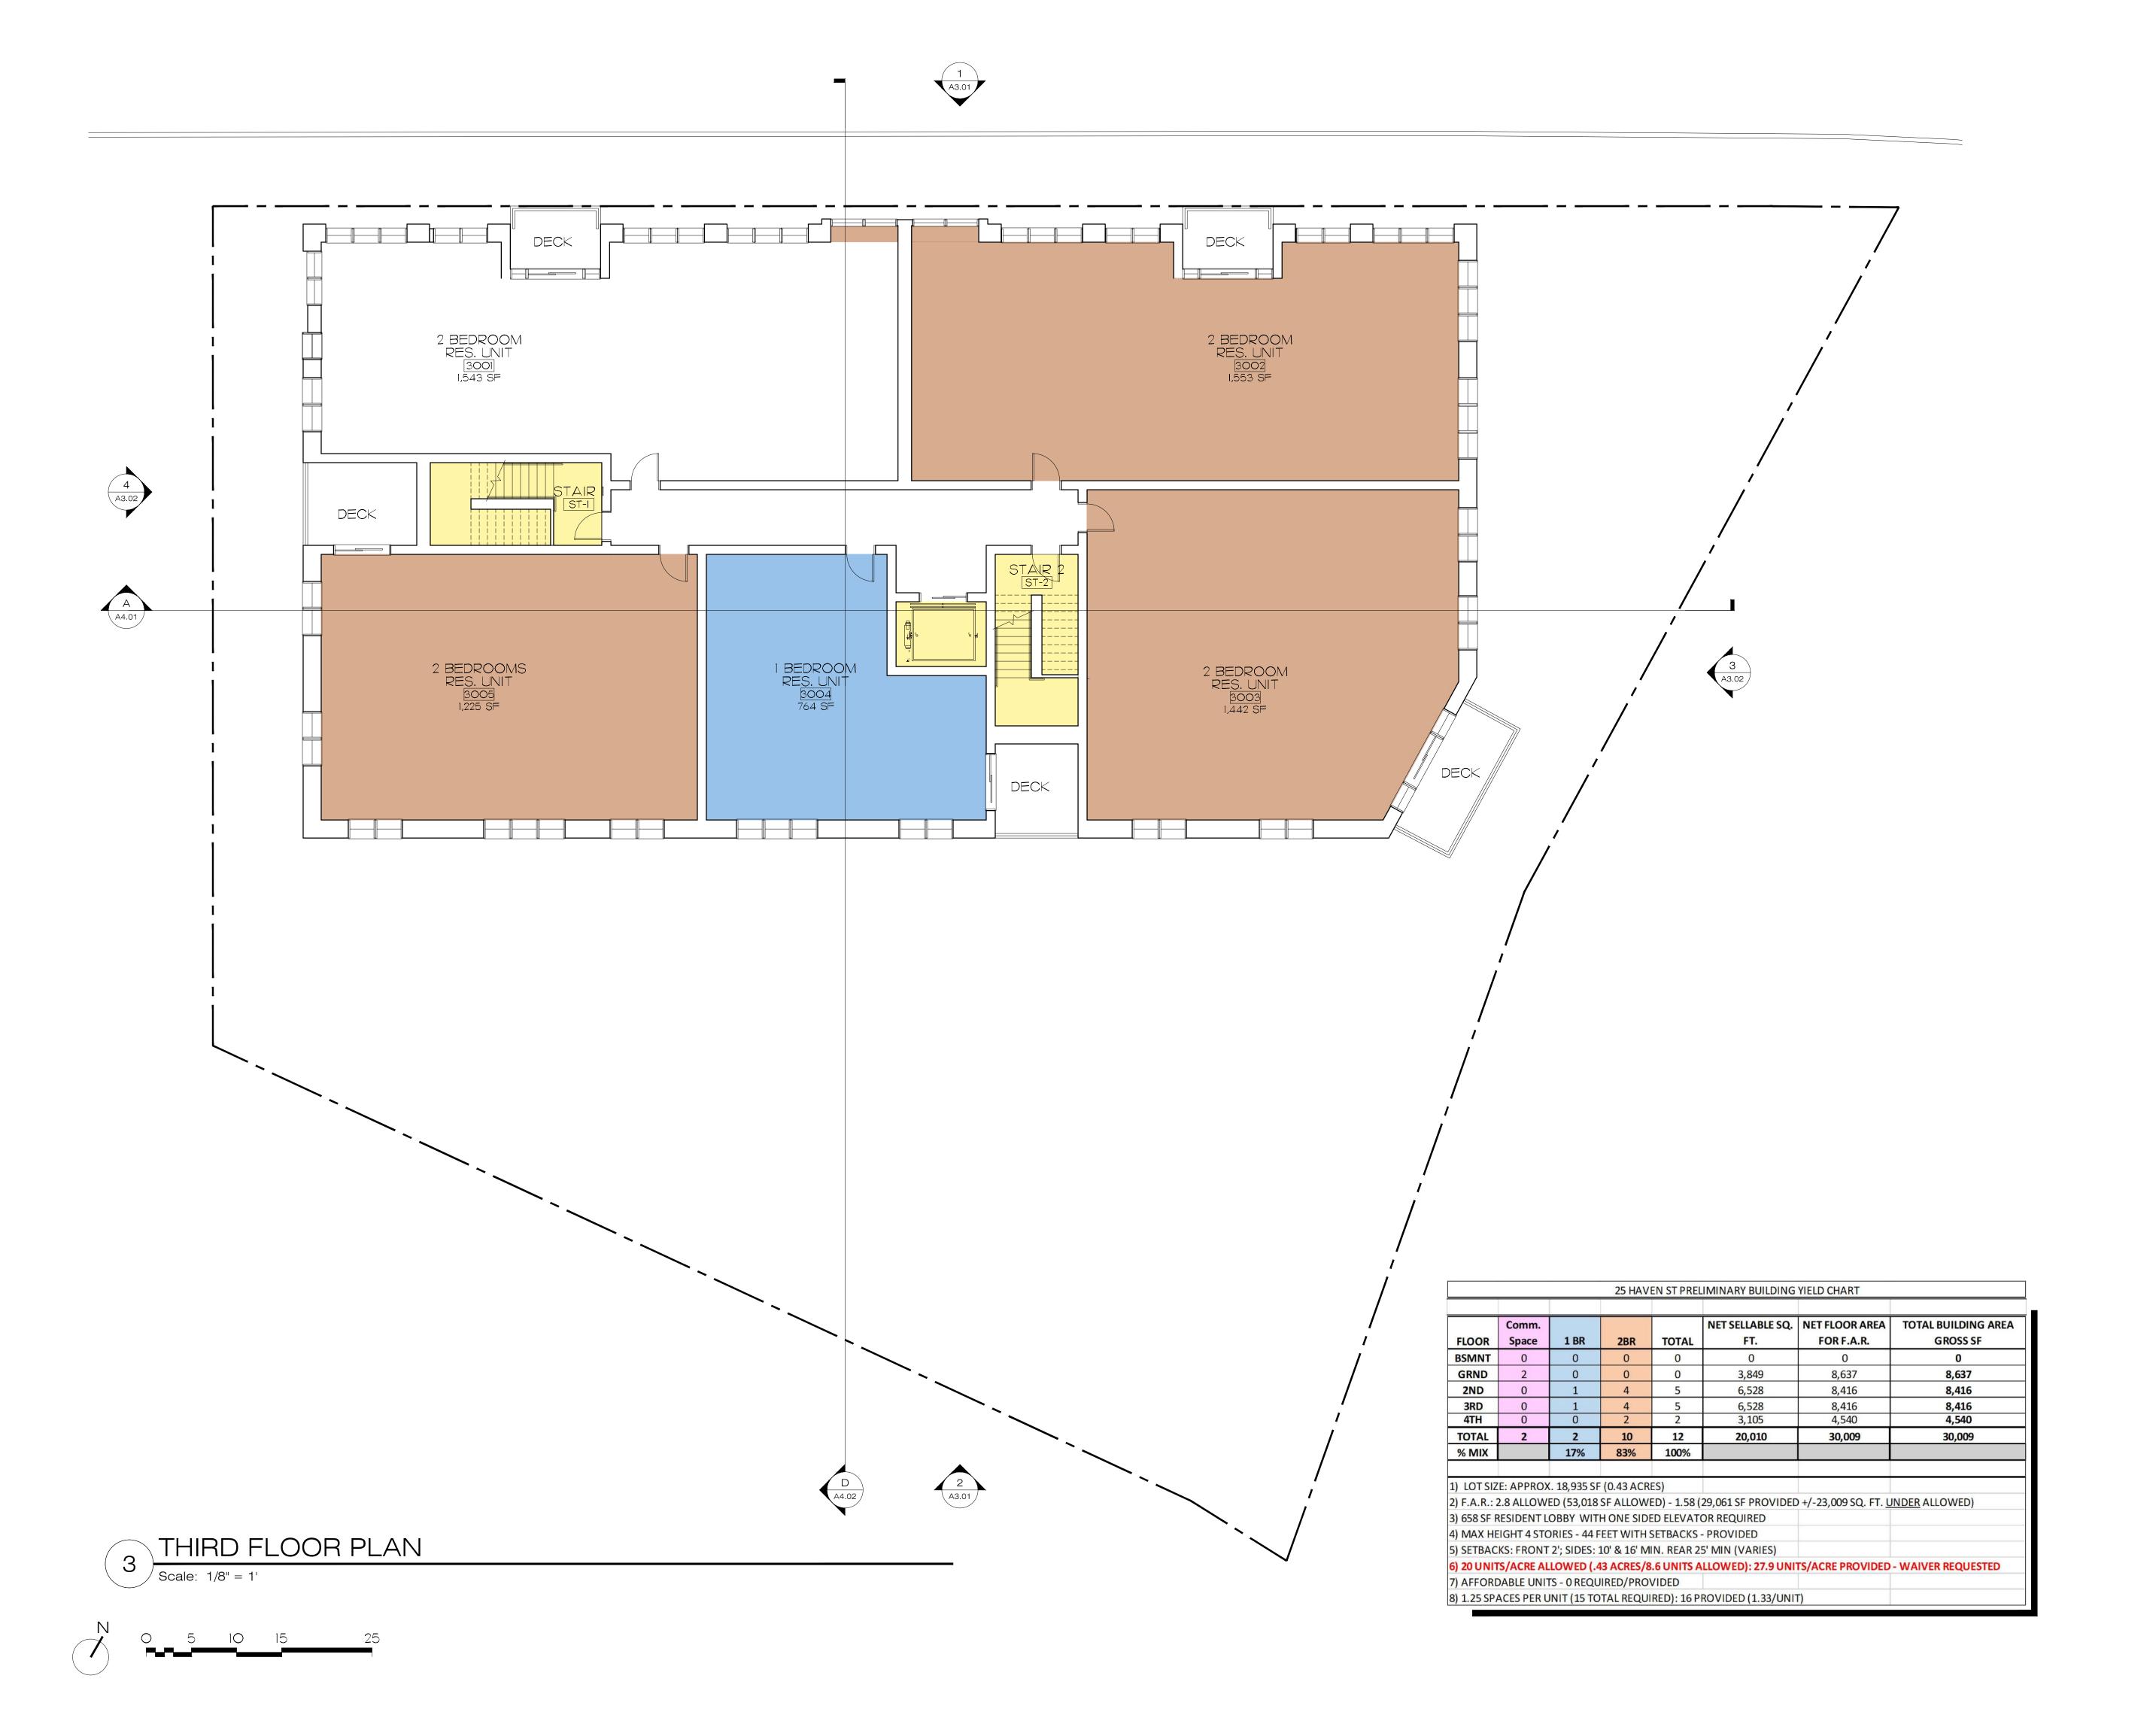

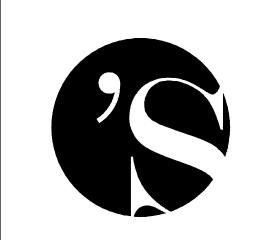

ARCHITECTURE INTERIORS I PLANNING 606 MAIN STREET, SUITE 3001 READING, MASSACHUSETTS 01867

Tel: (781) 439-6166 Fax: (781) 439-6170 www.osullivanarchitects.com

These drawings and specifications were prepared for use at the location indicated. Publication and use is expressly limited to the identified location. Reuse or reproduction by any method, in whole or in part, is prohibited without the written permission of O'Sullivan Architects, Inc.

© 2021 O'Sullivan Architects Inc.

25 Haven Street Reading, MA

Third Floor Plan



SCALE: As Noted

ISSUED / DRAWN BY

4/29/2022


REVISED / REVISED BY

10/24/2022 - REV SUBMISSION

JOB NO: 21015

SHEET NUMBER

A1.03

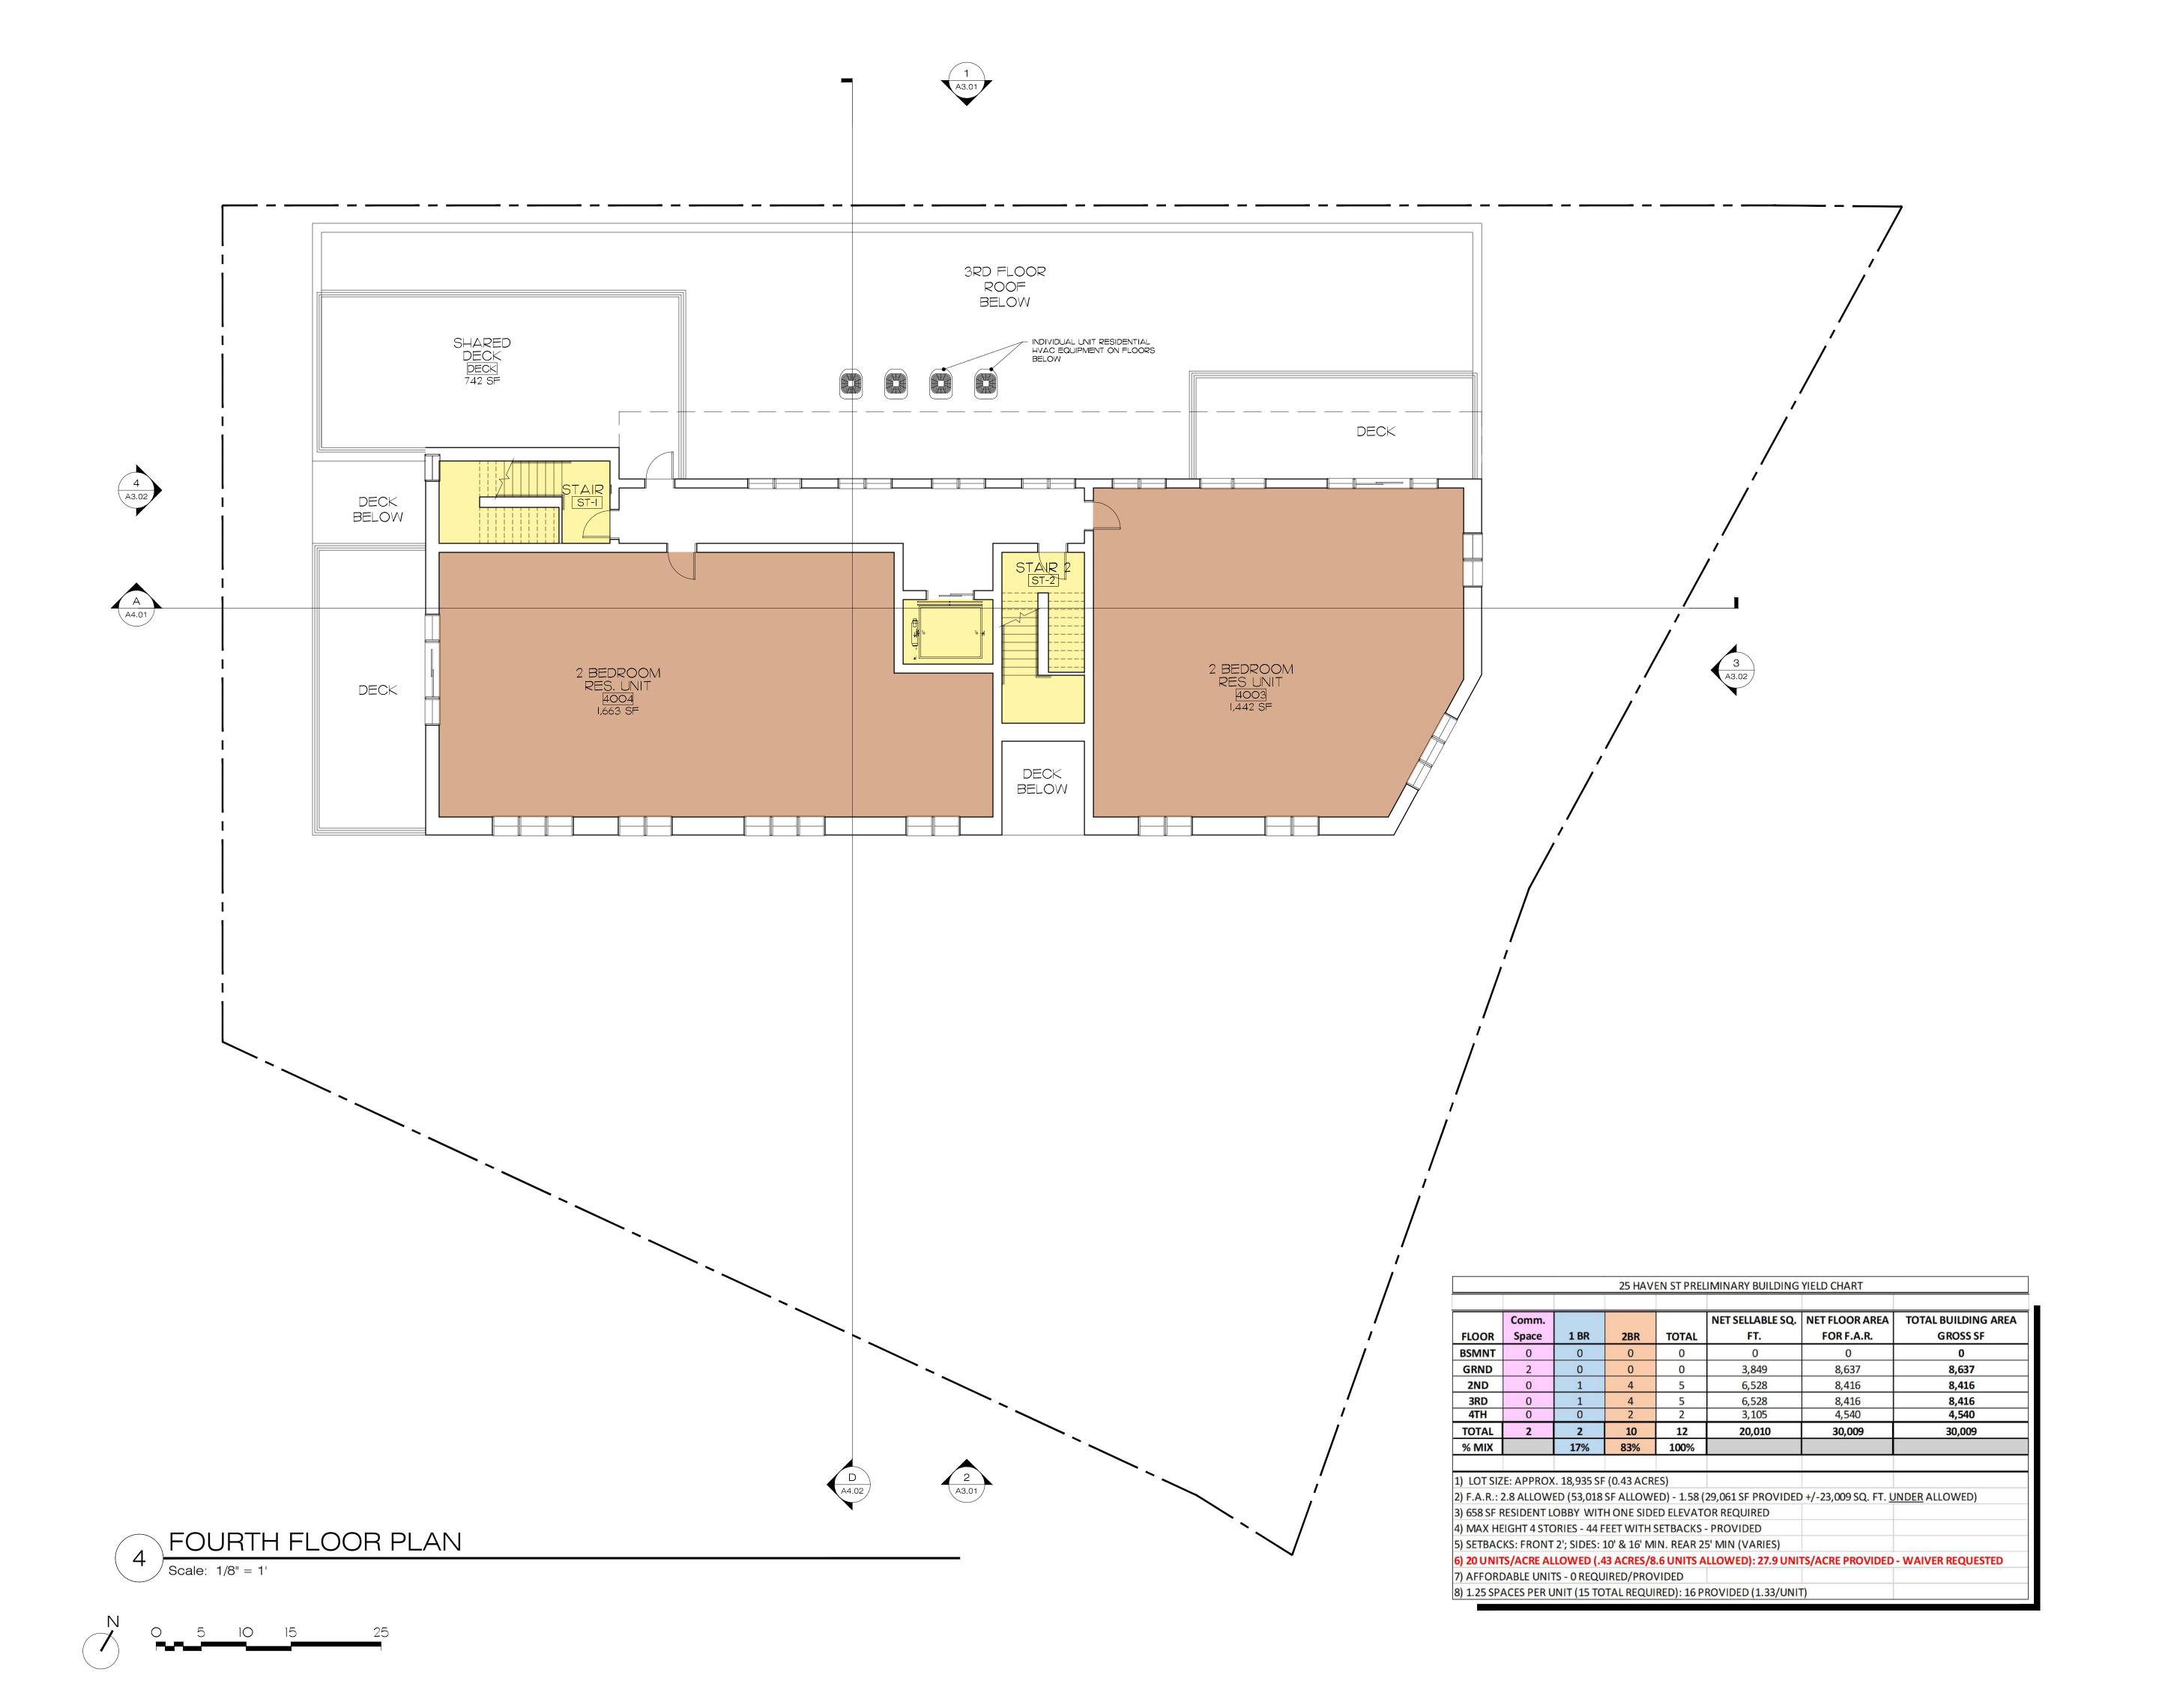



ARCHITECTURE INTERIORS PLANNING
606 MAIN STREET, SUITE 3001
READING, MASSACHUSETTS 01867

Tel: (781) 439-6166 Fax: (781) 439-6170 www.osullivanarchitects.com

These drawings and specifications were prepared for use at the location indicated. Publication and use is expressly limited to the identified location. Reuse or reproduction by any method, in whole or in part, is prohibited without the written permission of O'Sullivan Architects, Inc.

© 2021 O'Sullivan Architects Inc.

25 Haven Street Reading, MA

Fourth Floor Plan



SCALE: As Noted

ISSUED / DRAWN BY

4/29/2022


REVISED / REVISED BY

10/24/2022 - REV SUBMISSION

JOB NO: 21015

SHEET NUMBER

A1.04

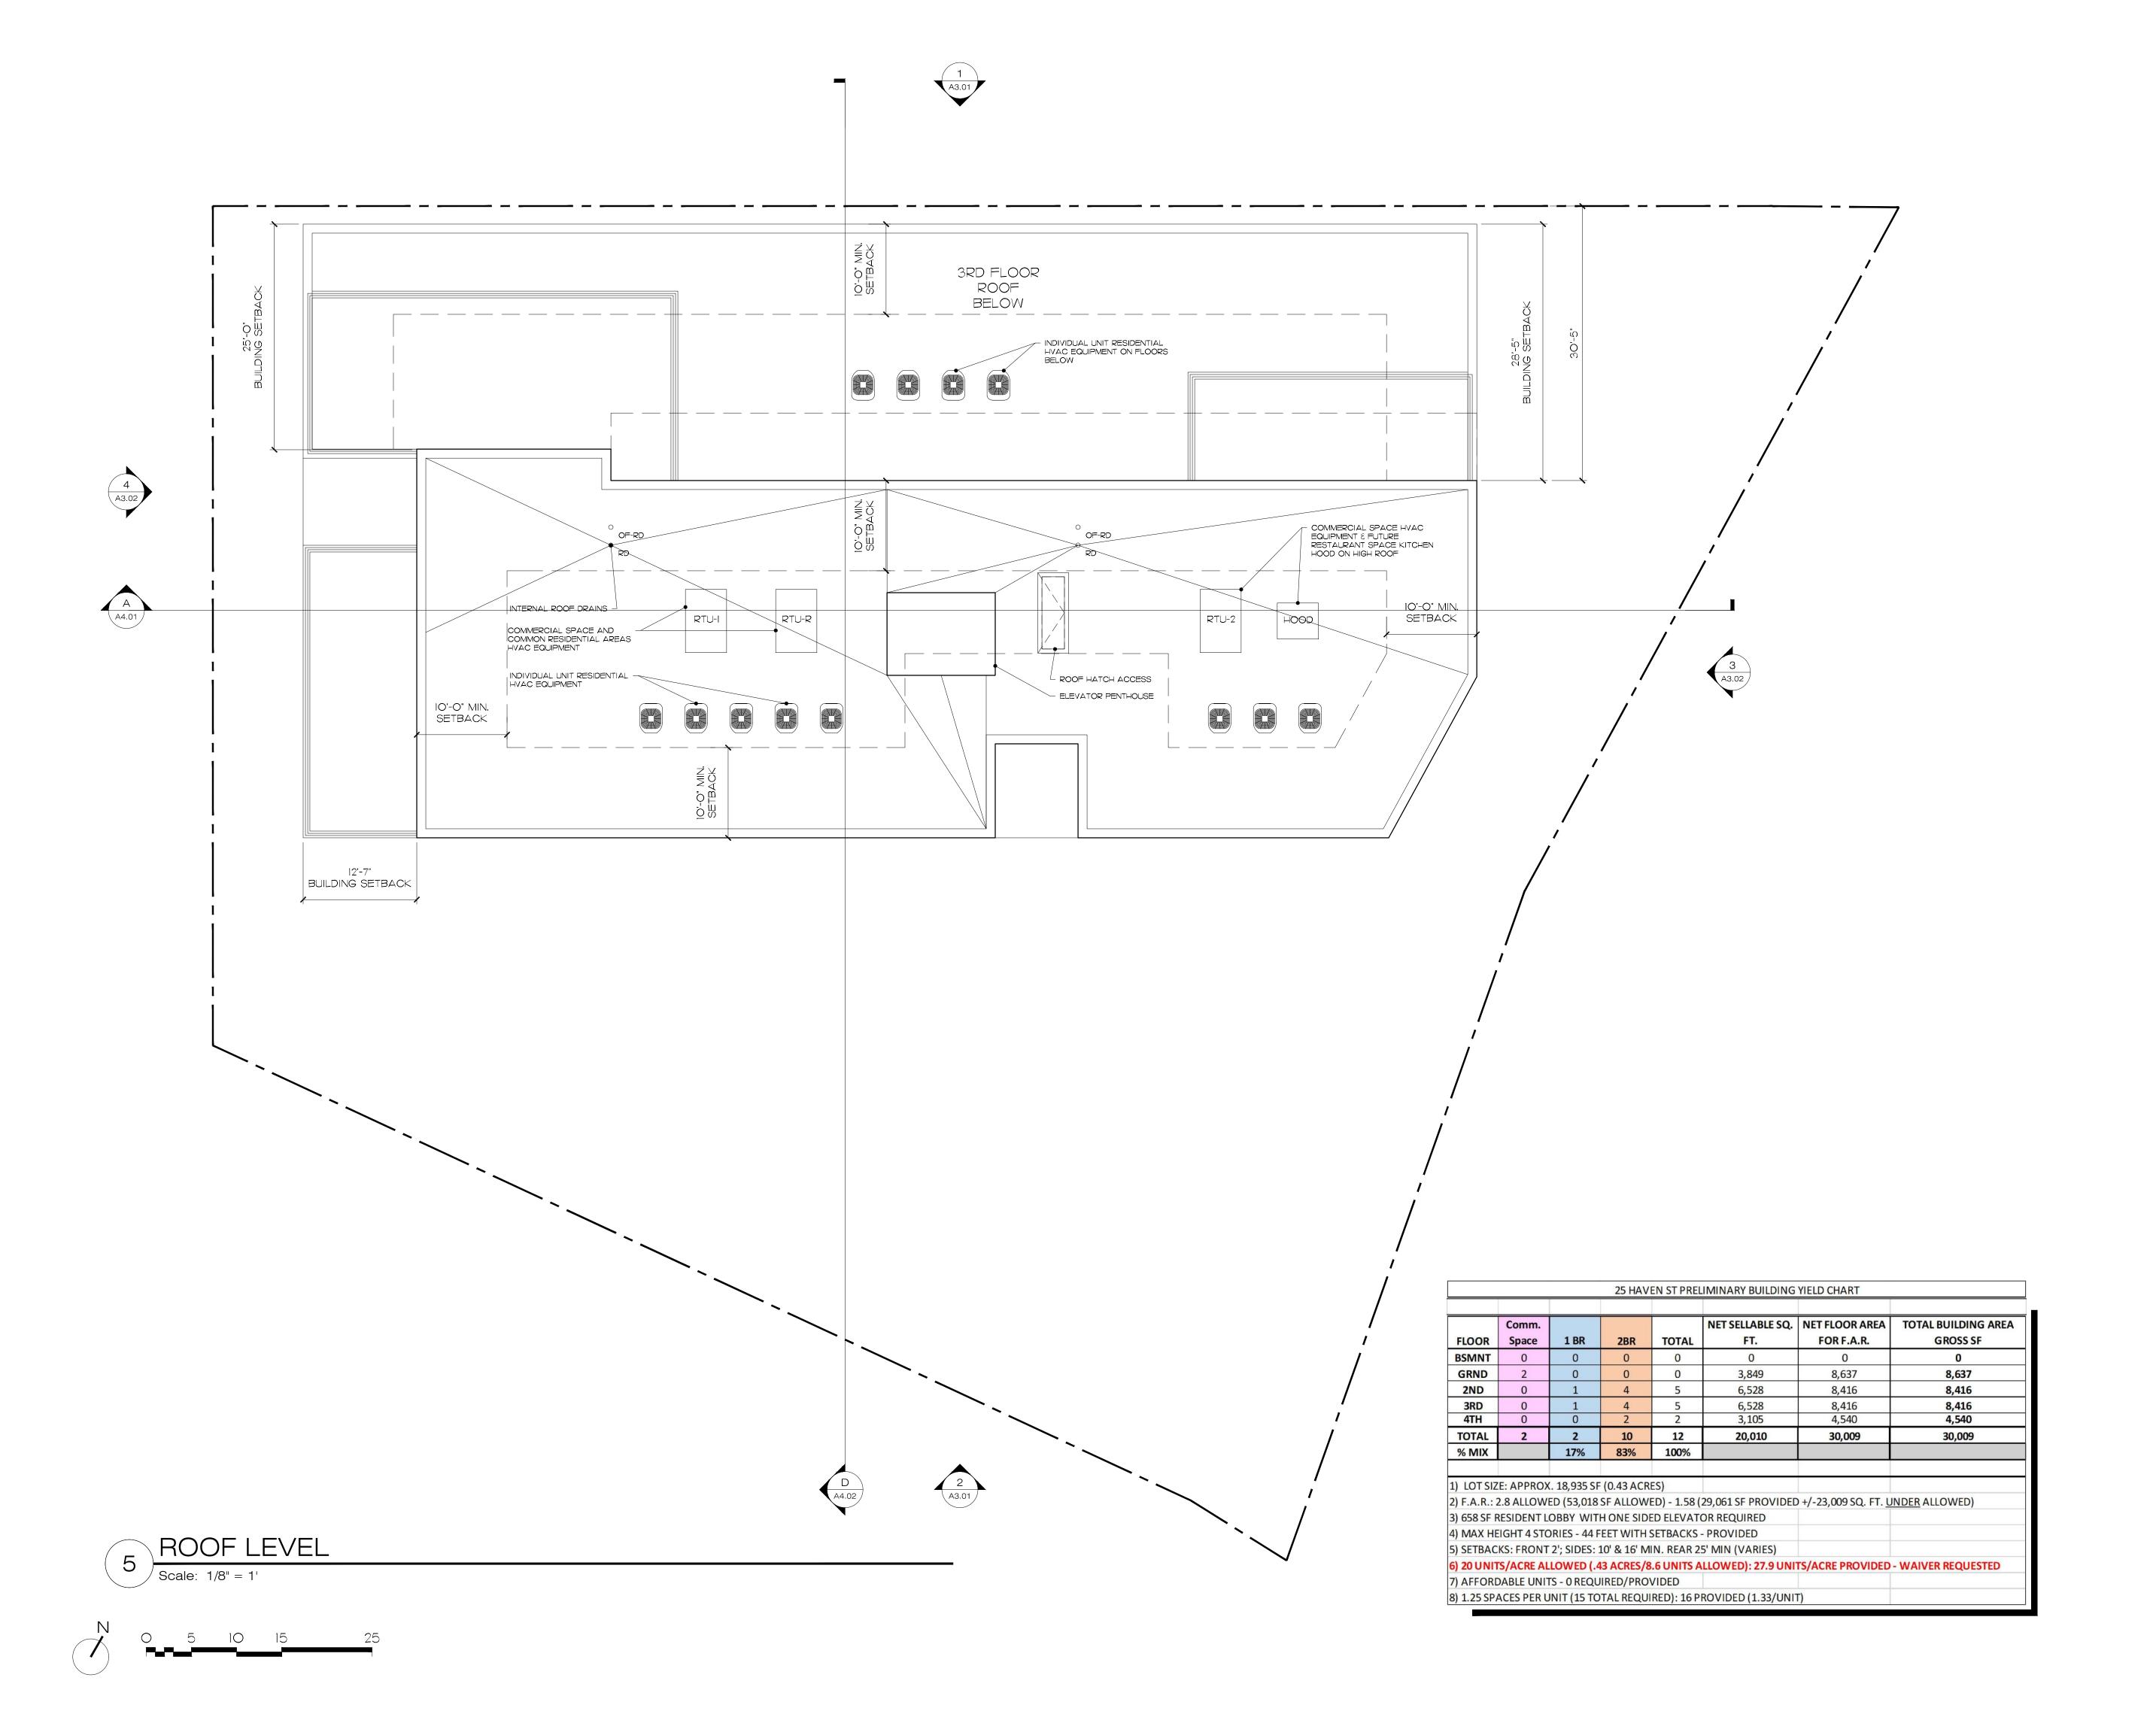




ARCHITECTURE ■ INTERIORS ■ PLANNING 606 MAIN STREET, SUITE 3001 READING, MASSACHUSETTS 01867

Tel: (781) 439-6166 Fax: (781) 439-6170 www.osullivanarchitects.com

These drawings and specifications were prepared for use at the location indicated. Publication and use is expressly limited to the identified location. Reuse or reproduction by any method, in whole or in part, is prohibited without the written permission of O'Sullivan Architects, Inc. © 2021 O'Sullivan Architects Inc.

25 Haven Street Reading, MA

Roof Level Plan

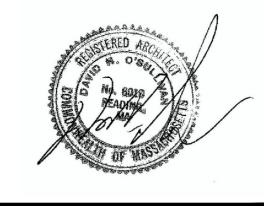

SCALE: As Noted

ISSUED / DRAWN BY 4/29/2022

REVISED / REVISED BY 10/24/2022 - REV SUBMISSION

JOB NO: 21015


SHEET NUMBER



FRONT ELEVATION (HAVEN STREET)



2 REAR ELEVATION (GREEN STREET) Scale: 1/8" = 1'

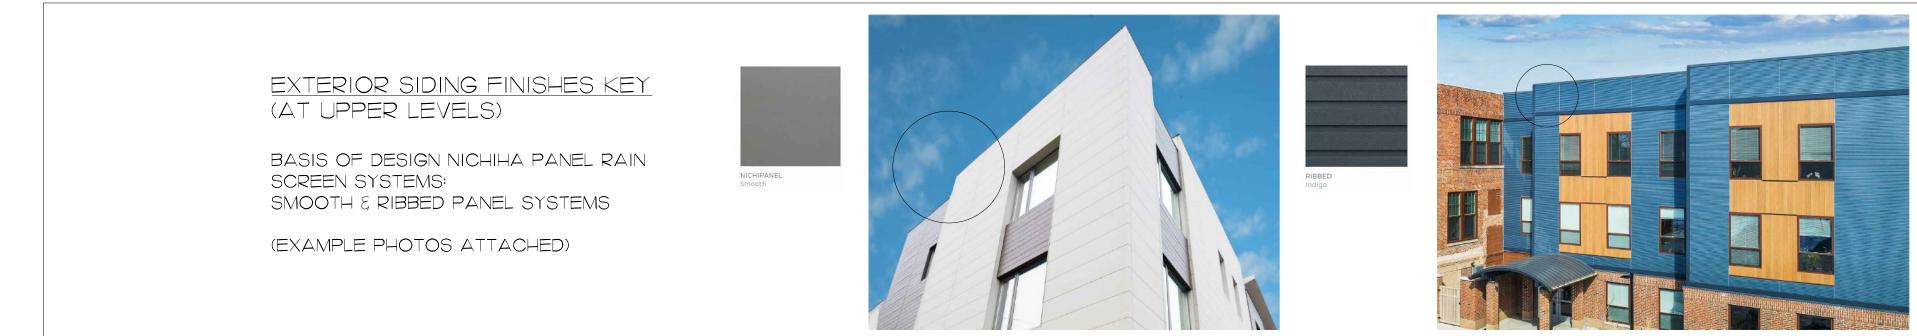

O'SULLIVAN ARCHITECTS, INC.

ARCHITECTURE INTERIORS PLANNING

606 MAIN STREET, SUITE 3001
READING, MASSACHUSETTS 01867


Tel: (781) 439-6166 Fax: (781) 439-6170 www.osullivanarchitects.com

These drawings and specifications were prepared for use at the location indicated. Publication and use is expressly limited to the identified location. Reuse or reproduction by any method, in whole or in part, is prohibited without the written permission of O'Sullivan Architects, Inc.

© 2021 O'Sullivan Architects Inc.

25 Haven Street Reading, MA

Elevations

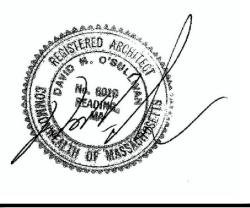

SCALE: As Noted

ISSUED / DRAWN BY 4/29/2022

REVISED / REVISED BY

10/24/2022 - REV SUBMISSION

JOB NO: 21015

SHEET NUMBER


A3.01








RIGHT ELEVATION

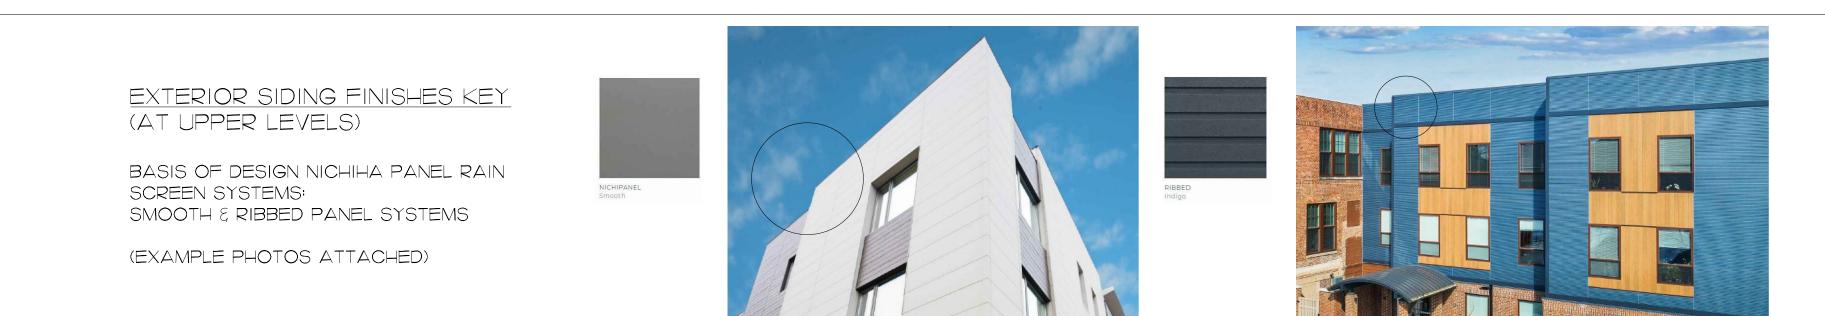

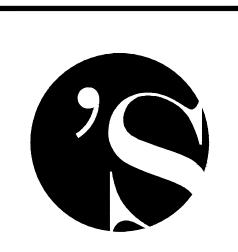

O'SULLIVAN ARCHITECTS, INC.

ARCHITECTURE INTERIORS PLANNING
606 MAIN STREET, SUITE 3001
READING, MASSACHUSETTS 01867


Tel: (781) 439-6166 Fax: (781) 439-6170 www.osullivanarchitects.com

These drawings and specifications were prepared for use at the location indicated. Publication and use is expressly limited to the identified location. Reuse or reproduction by any method, in whole or in part, is prohibited without the written permission of O'Sullivan Architects, Inc.

© 2021 O'Sullivan Architects Inc.

25 Haven Street Reading, MA

Elevations

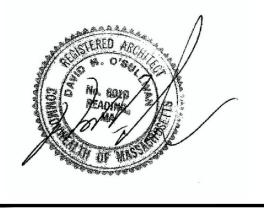

SCALE: As Noted

ISSUED / DRAWN BY 4/29/2022

REVISED / REVISED BY 10/24/2022 - REV SUBMISSION

JOB NO: 21015

SHEET NUMBER

A3.02



VIEW 1 FROM HAVEN ST.





O'SULLIVAN ARCHITECTS, INC.

ARCHITECTURE INTERIORS PLANNING
606 MAIN STREET, SUITE 3001
READING, MASSACHUSETTS 01867

Tel: (781) 439-6166 Fax: (781) 439-6170 www.osullivanarchitects.com

These drawings and specifications were prepared for use at the location indicated. Publication and use is expressly limited to the identified location. Reuse or reproduction by any method, in whole or in part, is prohibited without the written permission of O'Sullivan Architects, Inc.

© 2021 O'Sullivan Architects Inc.

25 Haven Street Reading, MA

Perpectives



SCALE: As Noted

ISSUED / DRAWN BY
4/29/2022

REVISED / REVISED BY
10/24/2022 - REV SUBMISSION

JOB NO: 21015

SHEET NUMBER

A3.10

VIEW 2 FROM HAVEN ST.


Scale: N.T.S.









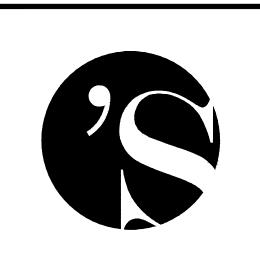

ARCHITECTURE INTERIORS PLANNING
606 MAIN STREET, SUITE 3001
READING, MASSACHUSETTS 01867


Tel: (781) 439-6166 Fax: (781) 439-6170 www.osullivanarchitects.com

These drawings and specifications were prepared for use at the location indicated. Publication and use is expressly limited to the identified location. Reuse or reproduction by any method, in whole or in part, is prohibited without the written permission of O'Sullivan Architects, Inc.

© 2021 O'Sullivan Architects Inc.

25 Haven Street Reading, MA

Perpectives

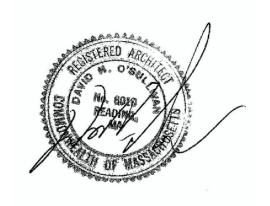

SCALE: As Noted

ISSUED / DRAWN BY 4/29/2022

REVISED / REVISED BY

10/24/2022 - REV SUBMISSION

JOB NO: 21015

SHEET NUMBER


A3.11









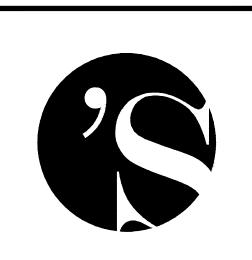

ARCHITECTURE INTERIORS PLANNING
606 MAIN STREET, SUITE 3001
READING, MASSACHUSETTS 01867

Tel: (781) 439-6166 Fax: (781) 439-6170 www.osullivanarchitects.com

These drawings and specifications were prepared for use at the location indicated. Publication and use is expressly limited to the identified location. Reuse or reproduction by any method, in whole or in part, is prohibited without the written permission of O'Sullivan Architects, Inc.

© 2021 O'Sullivan Architects Inc.

25 Haven Street Reading, MA

Perpectives



SCALE: As Noted


ISSUED / DRAWN BY 4/29/2022

REVISED / REVISED BY 10/24/2022 - REV SUBMISSION


JOB NO: 21015

SHEET NUMBER

A3.12

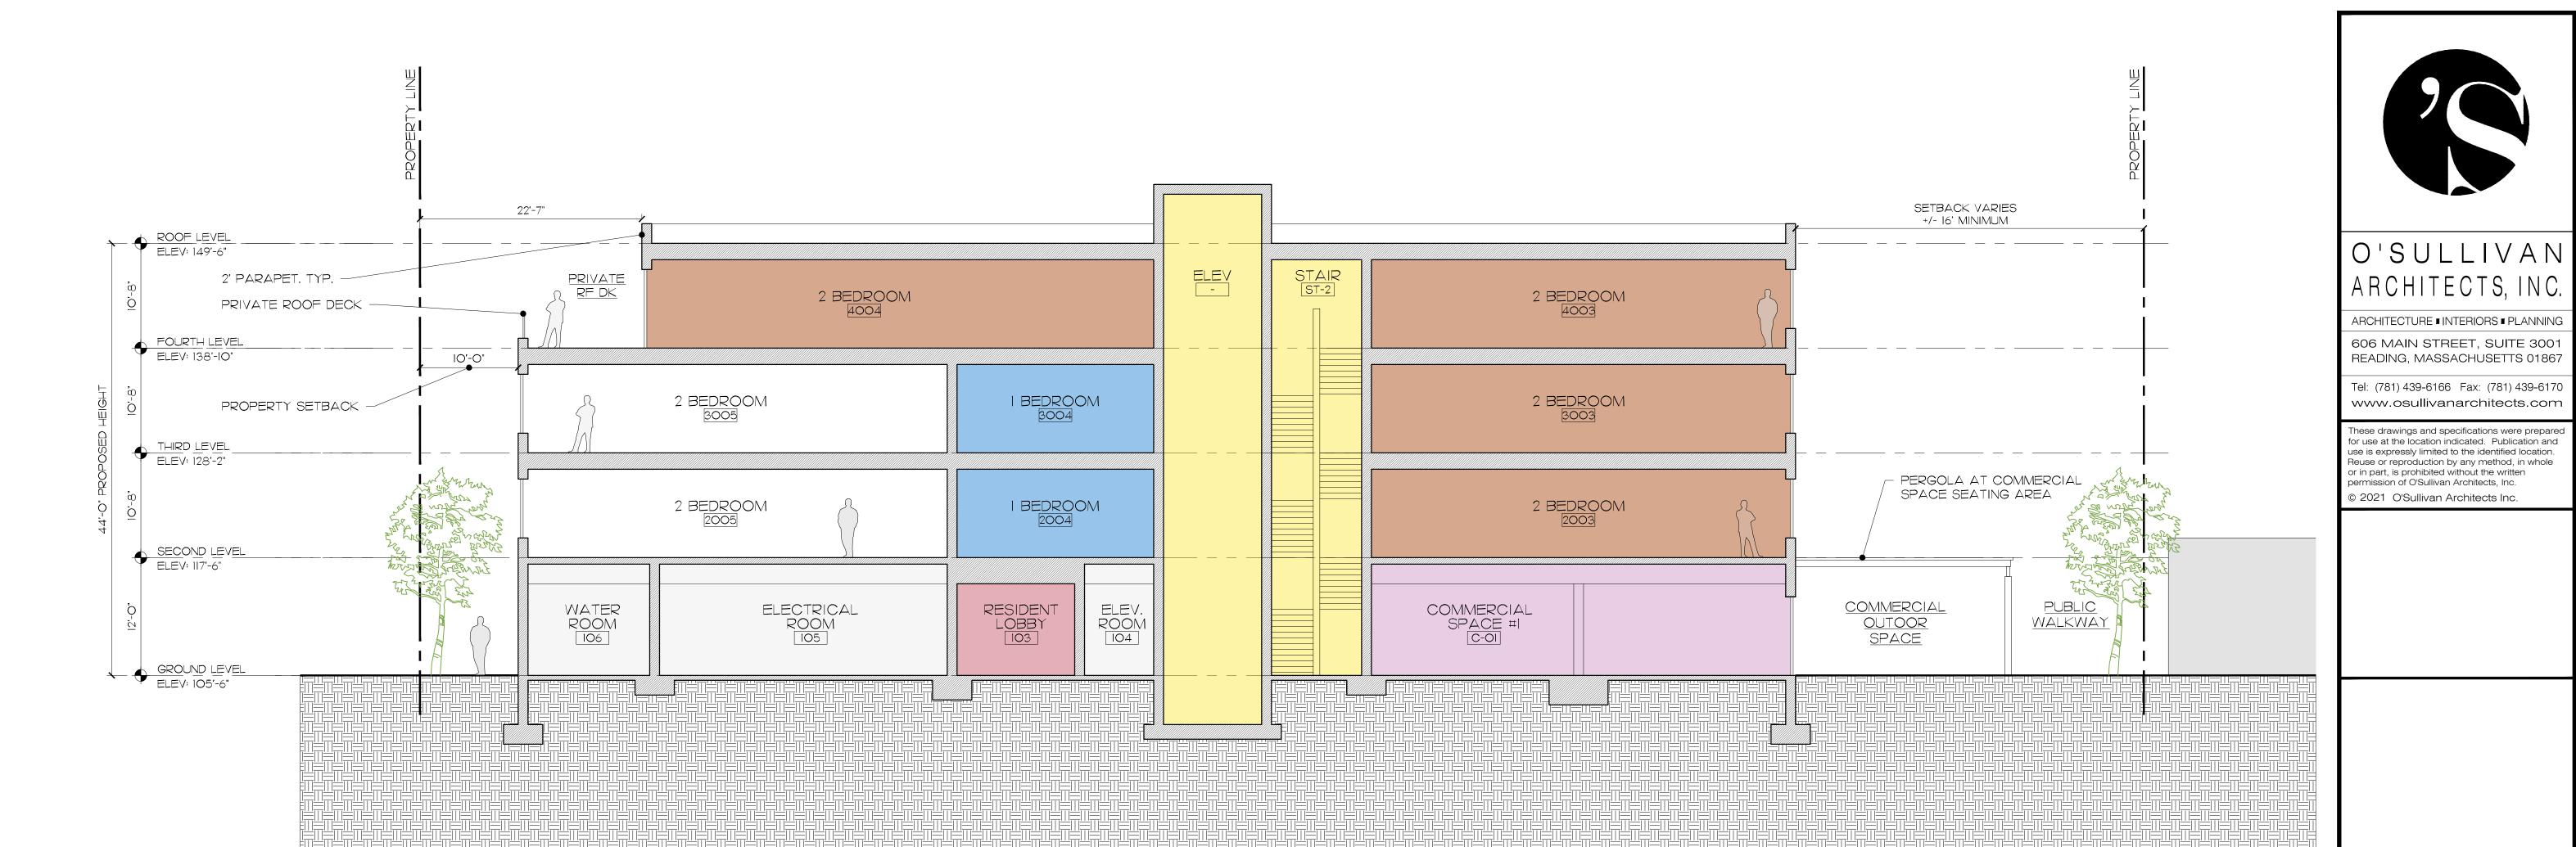



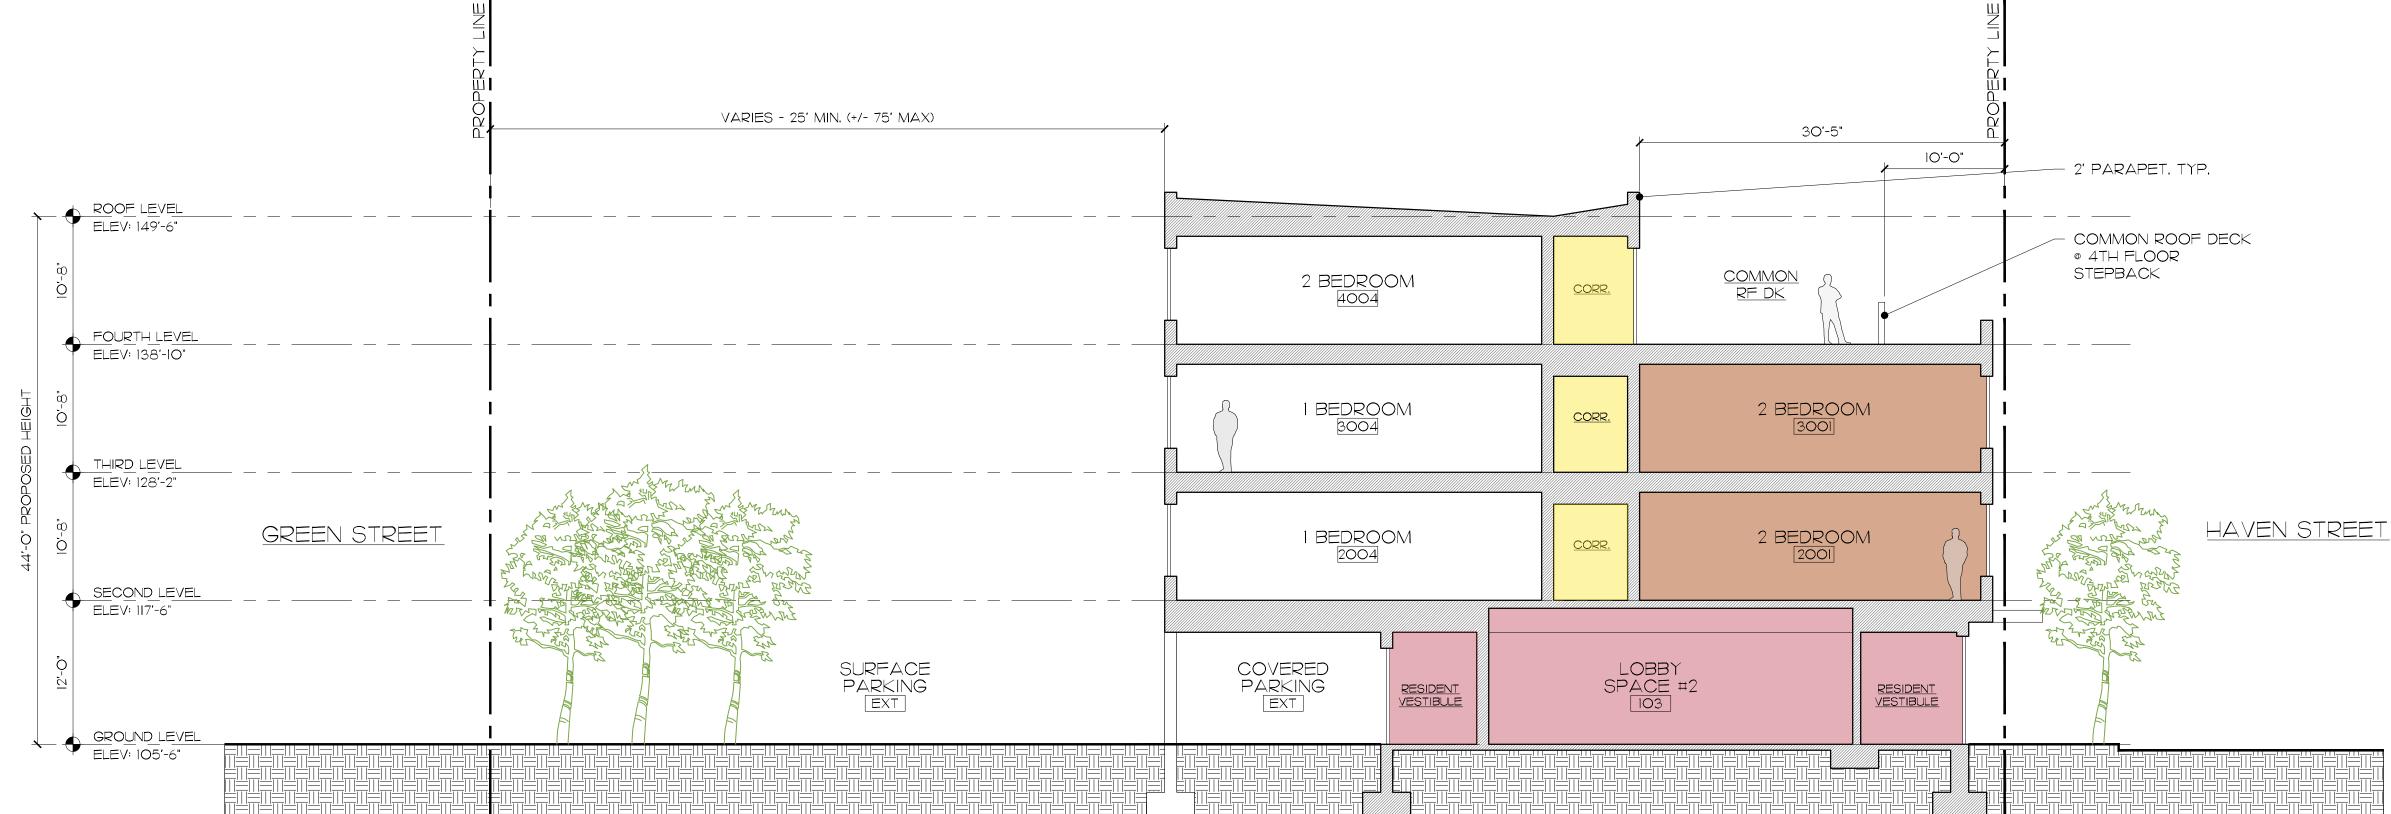

Sections



SCALE: As Noted

ISSUED / DRAWN BY 4/29/2022

REVISED / REVISED BY

10/24/2022 - REV SUBMISSION

JOB NO: 21015


SHEET NUMBER


A4.01


SECTION

Scale: 1/8" = 1'

01235 10 15 25

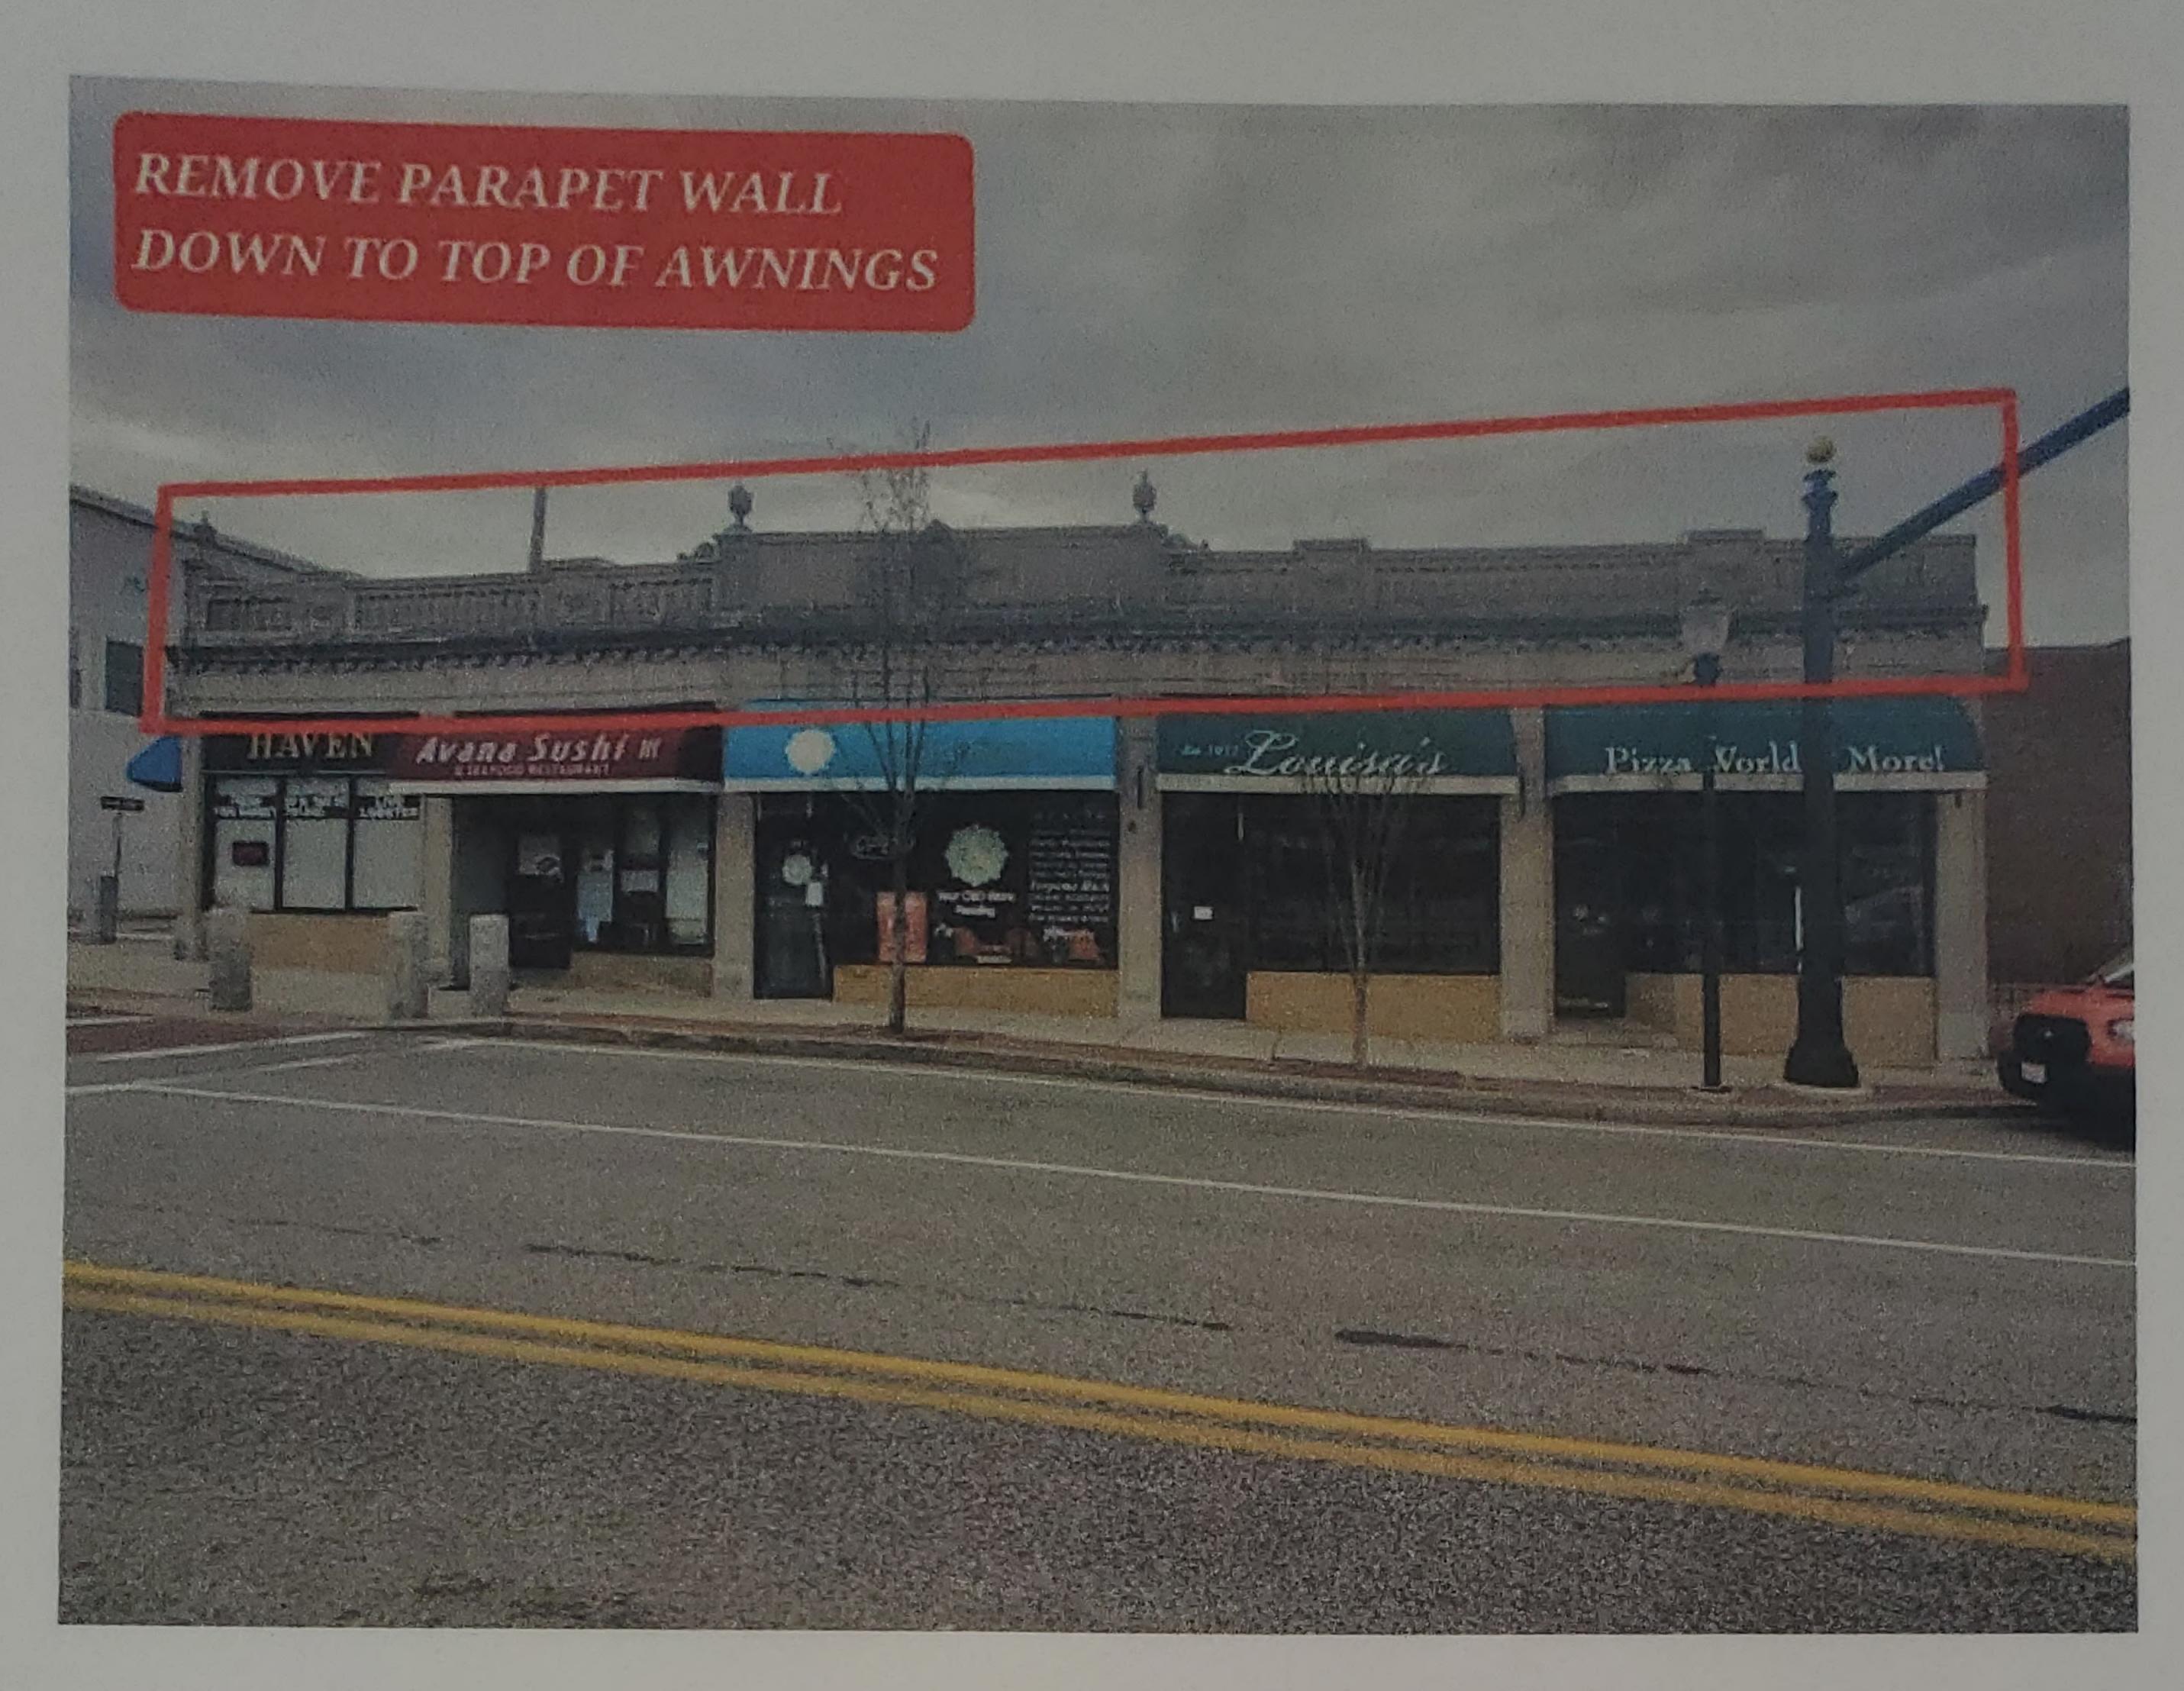

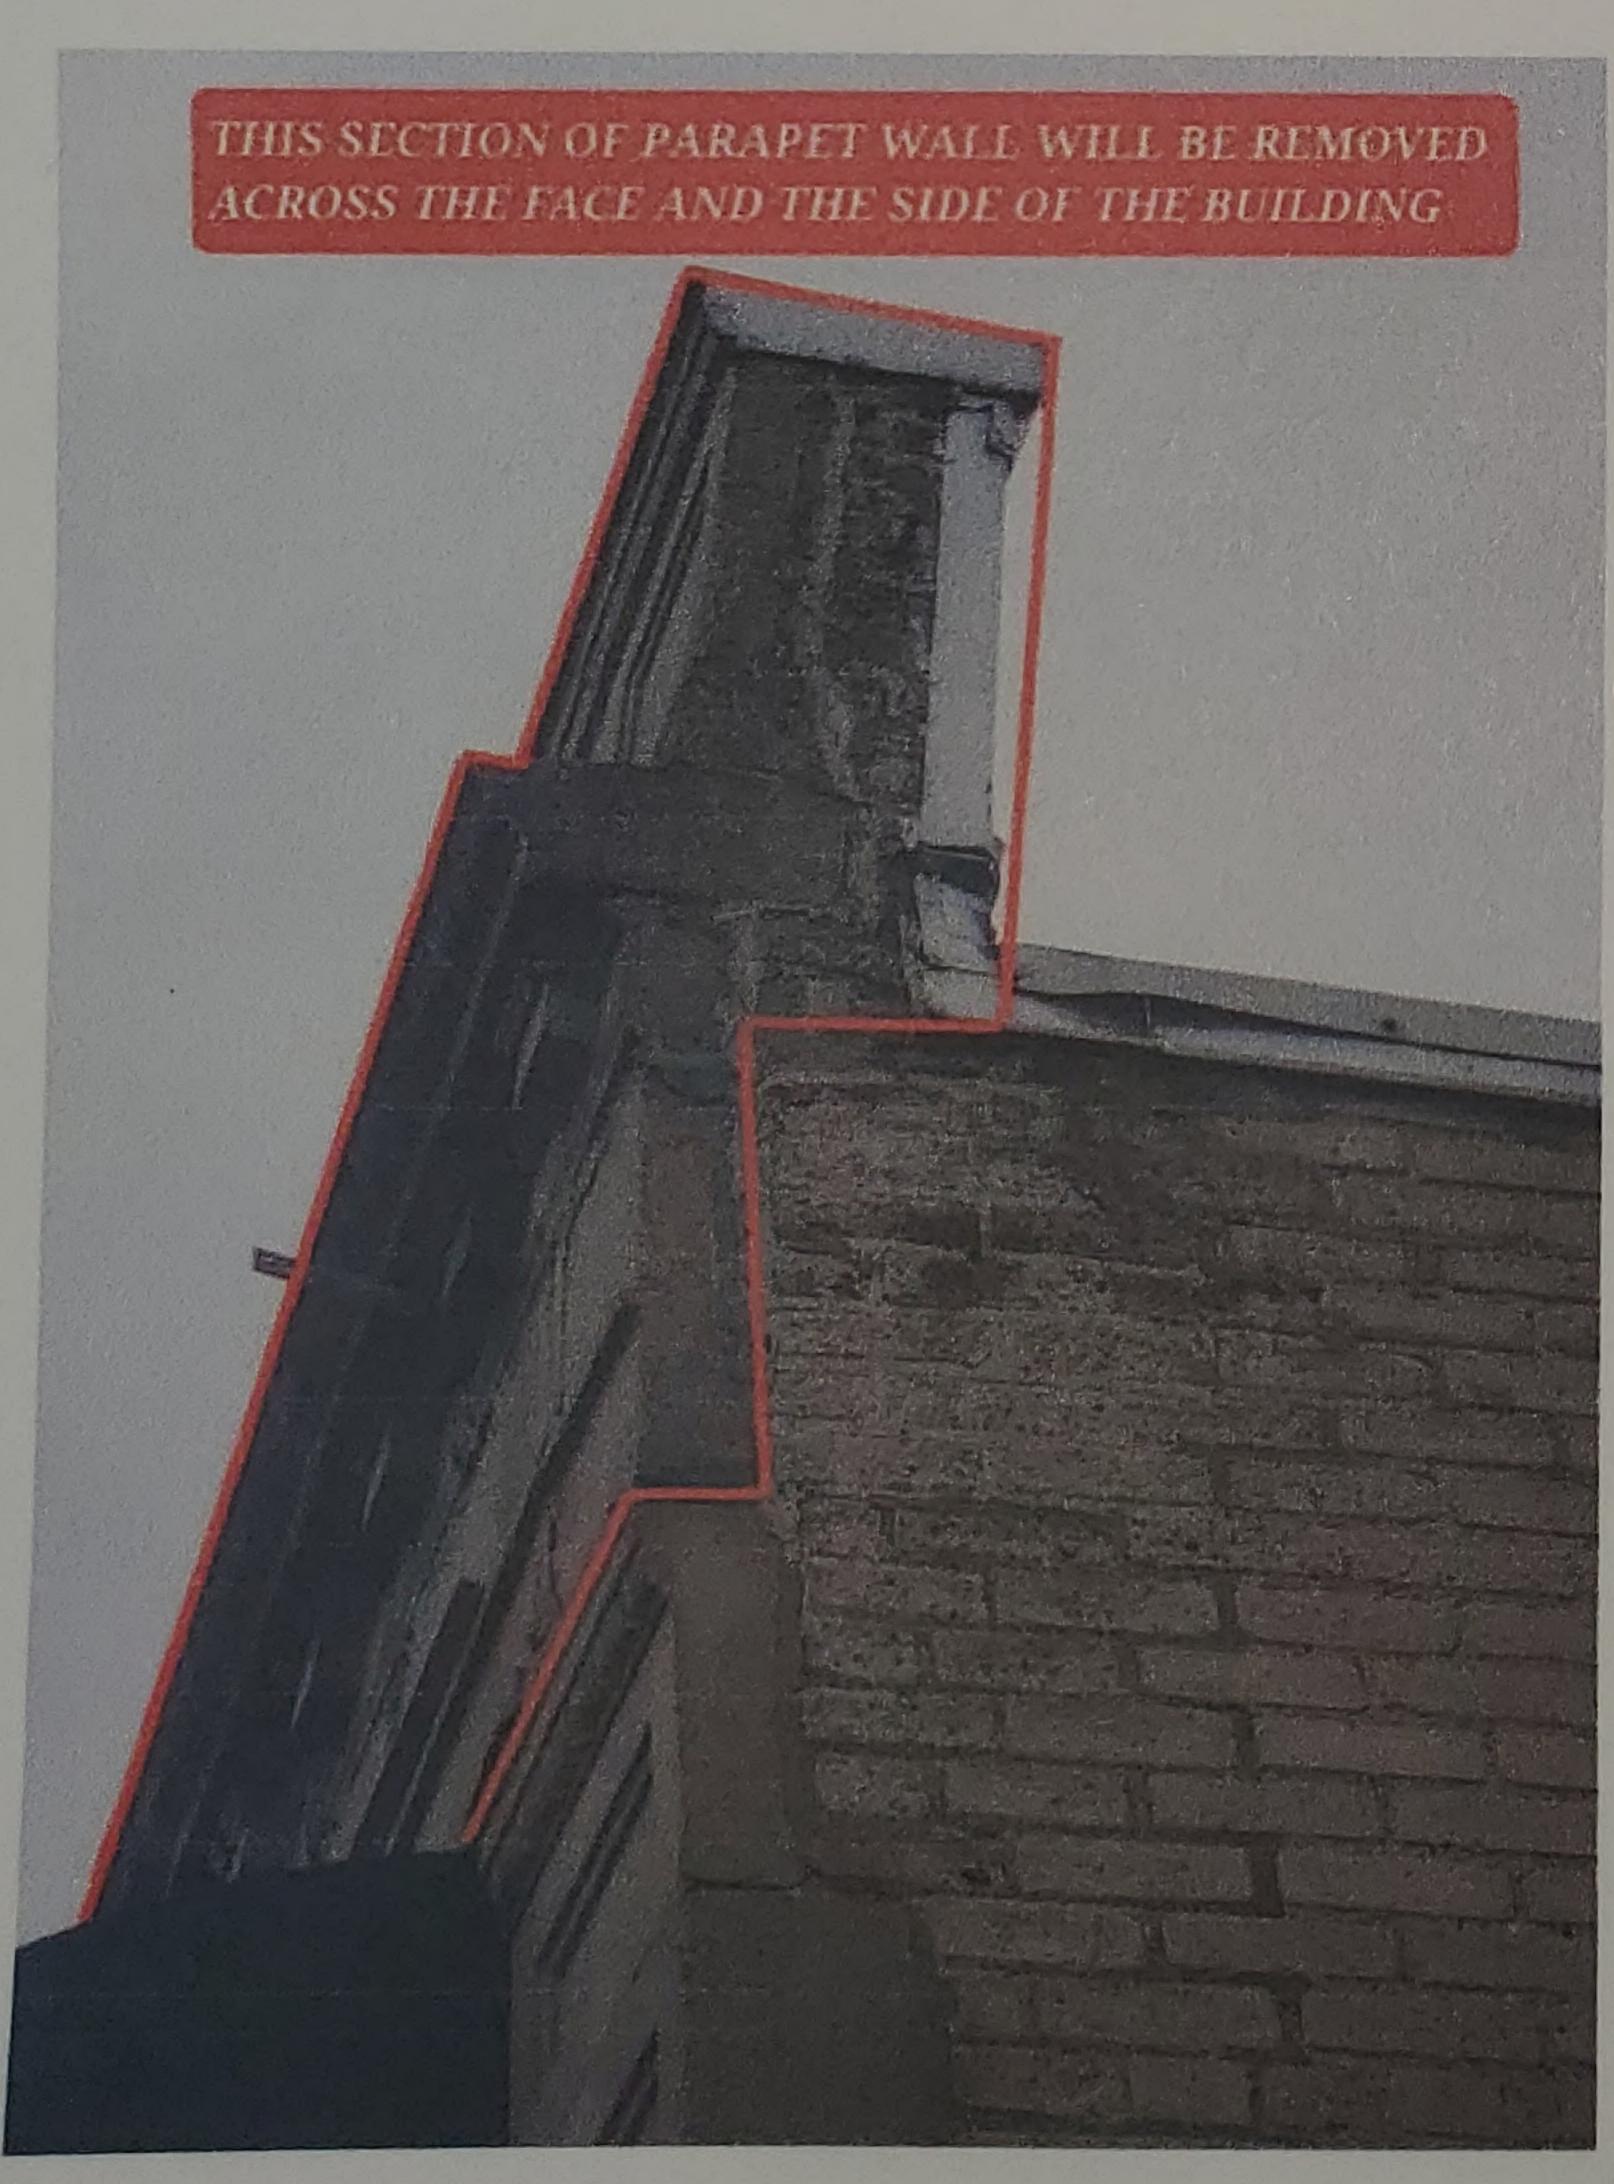

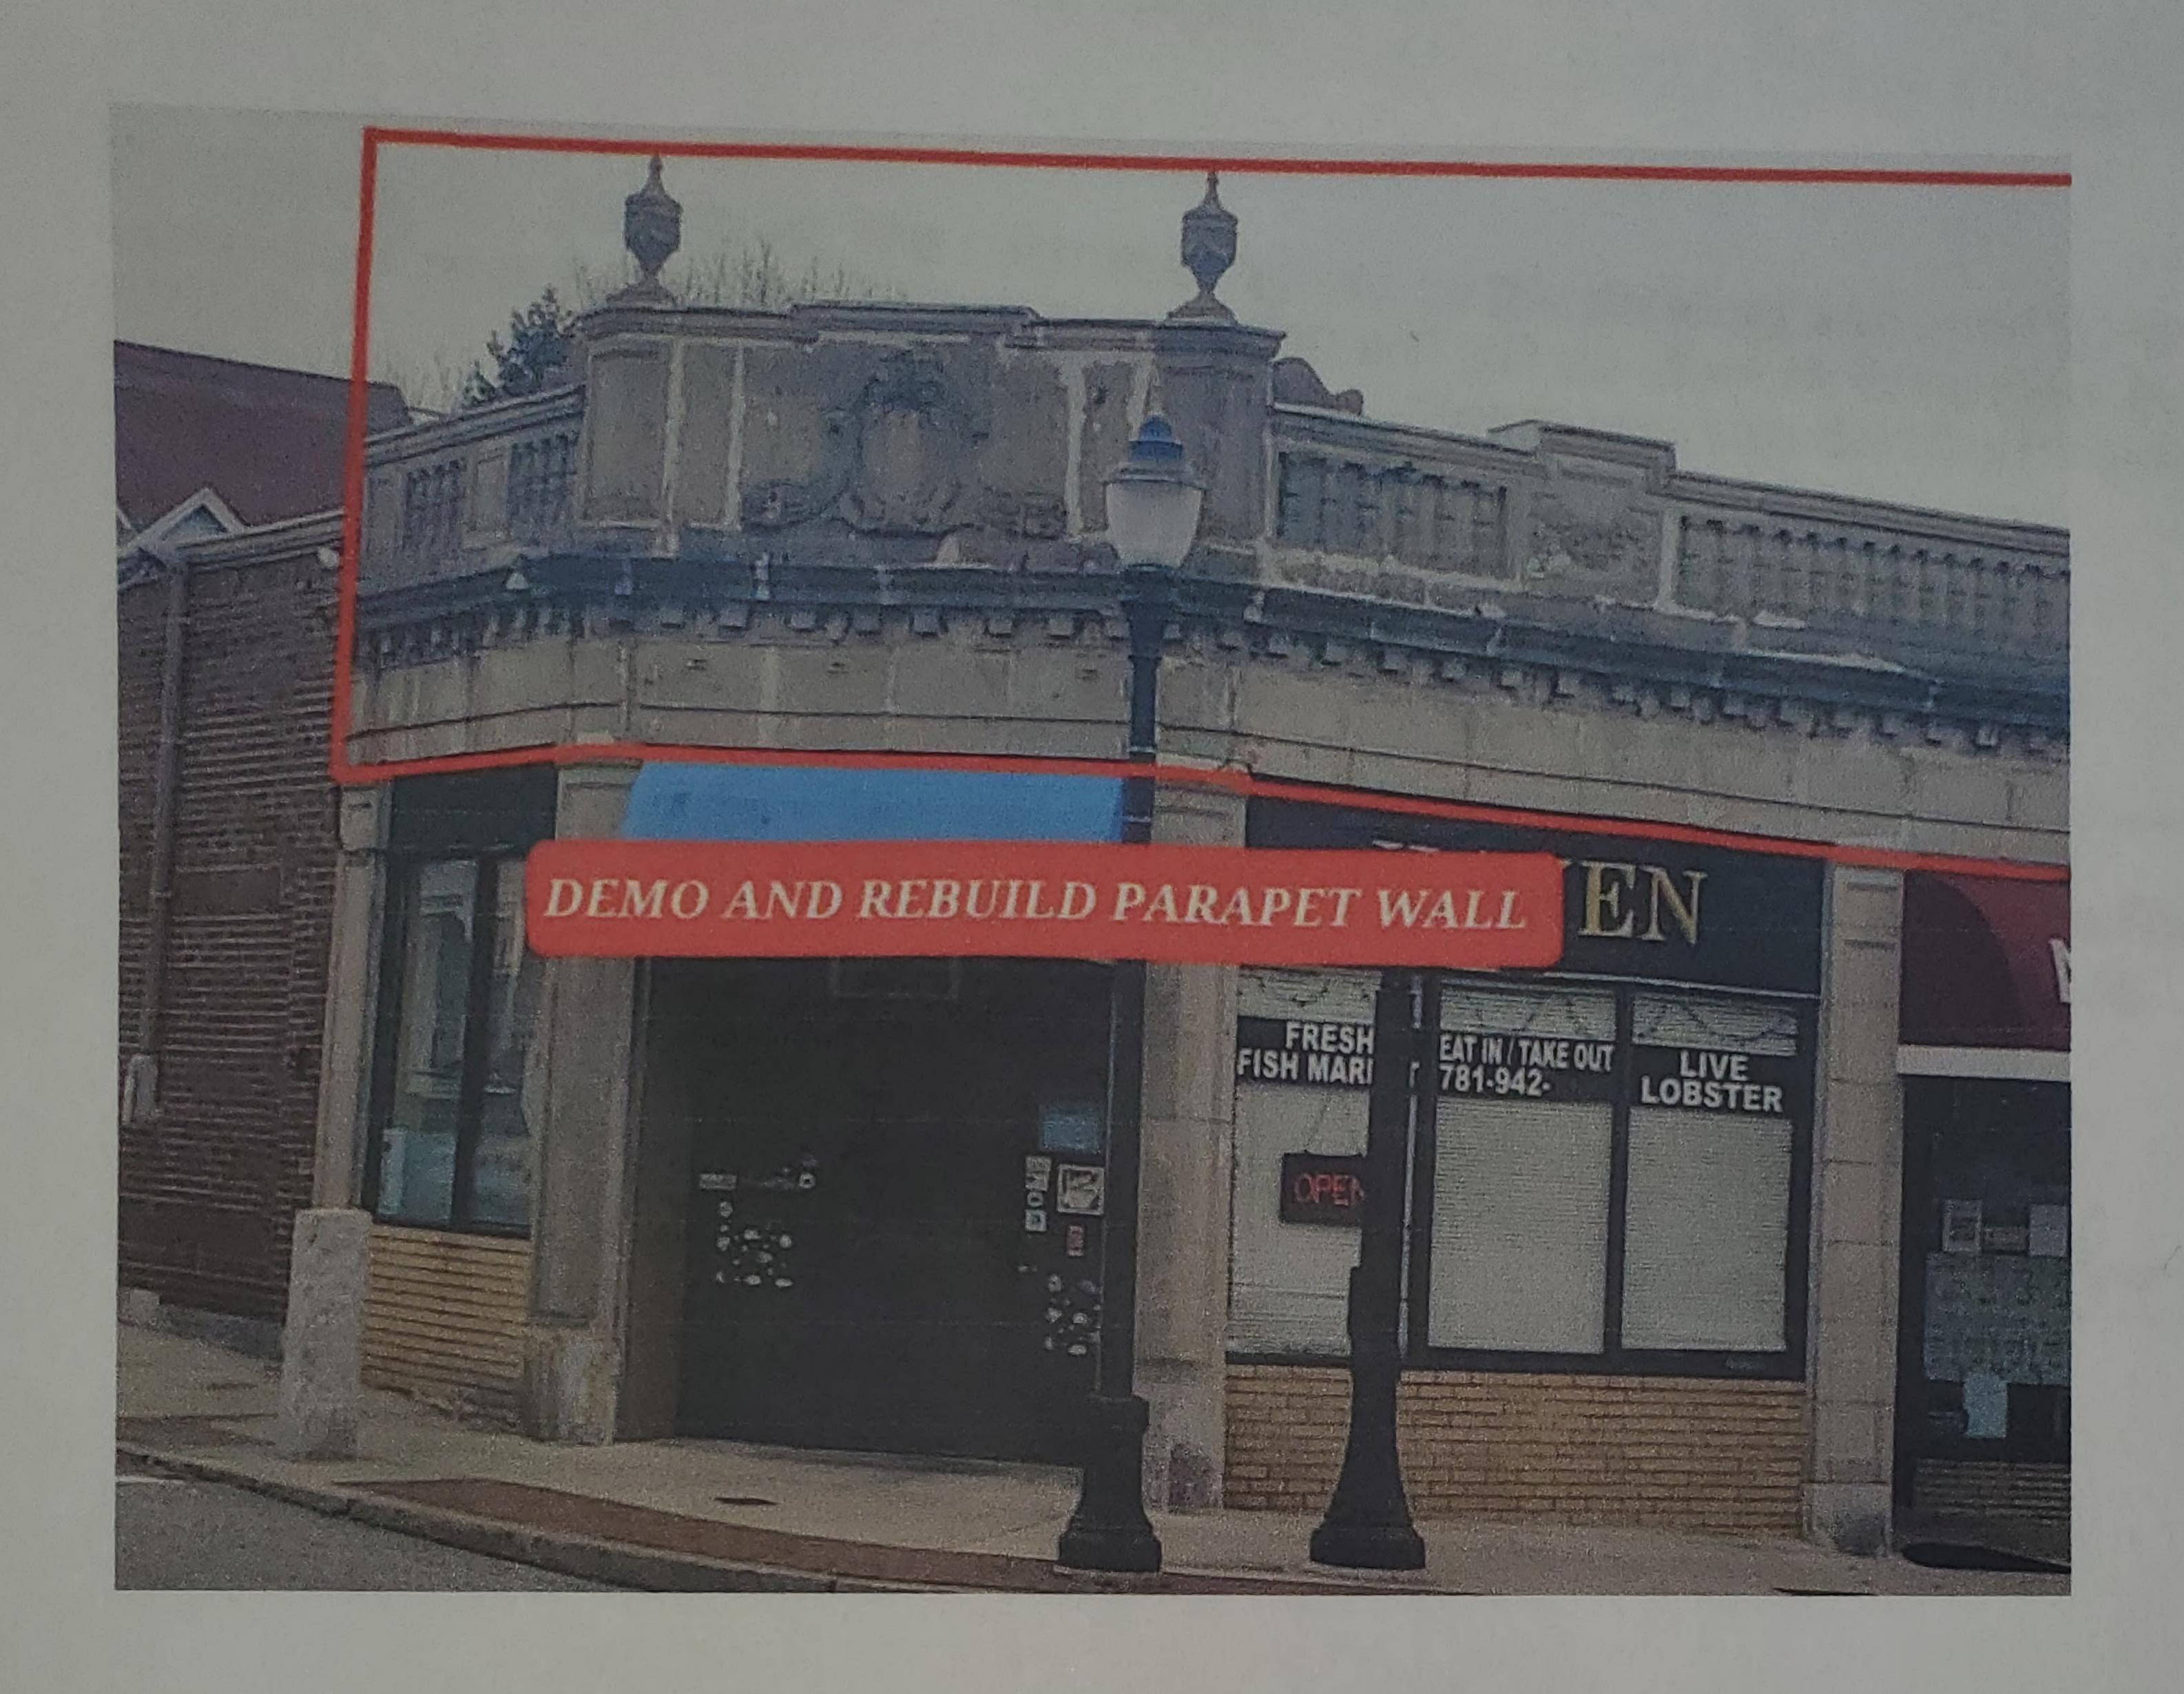

Building of Masonry on the Front

New Masonry will be built from under the roofline using one of three bricks which the owner will pick before we begin. As discussed with the owner it's better to keep everything simple and strong. We will build this parapet wall 3ft above roofline. We will be using wall ties to further strengthen the wall. These ties will be installed every 16 inches on center to provide equal strength throughout the entire masonry wall. There will also be a flashing between both bricks with the flashing on the back one course higher and the weep holes sitting on the outside course to push any moisture out.

Capping of Parapet

We Will be capping the wall using a bluestone.

Existing Stone Piers

All existing stone piers at the lower level will have all masonry joints cut out using angle grinders with vacuums attached so all dust is contained. We will then re-point using a type N cement and fine.

Sealing

After all the masonry has cured we will then apply three coats of a siloxane masonry sealer to further protect the new brickwork from any water damage.

Please see below all the products that will be used on this project.

John Screen

Owner

JMS Masonry & Restoration

m. 617-939-5348

Subtotal	\$84,000.00
Total	\$84,000.00



George Liakos/ Panagota Flaherty/
Theodoris Gregoris
583 Main Street
Reading, Ma

JMS MASONRY AND RESTORATION LLC

4 Manison Street Stoneham, Ma 02180

Phone: +Cell 617 939 5348 Office 781 435 0498

Email: jmsmasonry80@gmail.com Web: www.Jmsmasonryma.com

Estimate # 030379

Date 04/07/2022

Business / Tax # JMS Masonry

Description Total

Parapet wall \$84,000.00

Staging

Pipe staging will be erected on the front using walkthrough frames so all pedestrians and business owners can continue as usual. We will add plywood on top of the first lift and keep it tight to the building so that we are sectioned off from all traffic beneath us along with lighting so the area is seen at night for safety. We will have the staging one frame higher than the building with dust nets added to contain all debri and dust to a confined area. All trash will be removed and dumped everyday and staging cleaned everyday. We do not leave trash on jobs!

Roofing

10ft from the existing rubber roof will be cut back and removed in order for the work to be performed from both sides. We will cover the roof using temporary rubber every evening after the work day has ended. Once all the new masonry has been built our roofer will then install new permanent rubber that will attach to our new masonry and leave it water tight.

Demolition

All demolition will be done with precision to ensure the safety of our workers and also the pedestrians. We will be removing a set amount each day that will be marked out by me personally and performed under my watch. The amount that is demolished each day will also be dumped that same day we will not allow debri or trash to accumulate. We will be removing the parapet wall roughly 16 inches below roof line or to where the relieving angle iron is set. We will inspect the angle iron to see if it can be reused and flashed. if i find that its no longer structurally sound it will be replaced with a new dipped steel.

Preparation For New Masonry

Before any brickwork begins we will be inspecting the inside walls for any water damage or rust on the steels that if found will be restored insuring that our foundation before we begin building is correct. All steels will be flashed using an ice/water rubber membrane with weep holes added for any trapped moisture to escape.